TENANT IMPR	OVEMEN	<b>TS for SU</b> HALL
		PRICING PLANS
(NOT FOR CONSTRUCTION)          CONTACT INFORMATION         TENANT         SUPERIOR COURT OF CALIFORNIA, COUNTY OF SANTA CLARA         GEORGIA KU         191 NORTH FIRST STREET         SAN JOSE, CA 95113         P: 408.515.9473         E: gku@scscourt.org         CONTACTOR - TBD         COMPANY         CONTACT         ADDRESS         P:         E:	ARCHITECT STUDIO G ARCHITECTS INC. KELLY SIMCOX 299 BASSET STREET, SUITE 250 SAN JOSE, CA 95110 P: 408.283.0100 PROJECT CONTACT KAI NGUYEN E: kai@studiogarchitectsinc.com P: 408.750.7457	(NOT FOR CONSTRUCTION VICINITY MAP
		PROJECT SCOPE         THIS IS A TENANT IMPROVEME         DEMOLITION         SITE/EXTERIOR         • NONE         INTERIORS         • REMOVE EXISTING FL         NEW CONSTRUCTION         SITE/EXTERIOR         • NONE         INTERIORS         • NONE         INTERIORS         • NONE         INTERIORS         • UPGRADE FLOORING

# JPERIOR COURT OF CALIFORNIA, COUNTY OF SANTA CLARA OF JUSTICE EAST, 190 W. HEDDING STREET, SAN JOSE, CA 95110 4TH FLOOR, DEPARTMENT 30

CONSTRUCTION DOCUMENTS (NOT FOR CONSTRUCTION)

A.P.N.:

ZONING:

SITE AREA:

OCCUPANCY:

AREA OF WORK:


FIRE SPRINKLERS:

APPLICABLE CODES:

PROJECT DATA

CONSTRUCTION TYPE:

NUMBER OF STORIES:

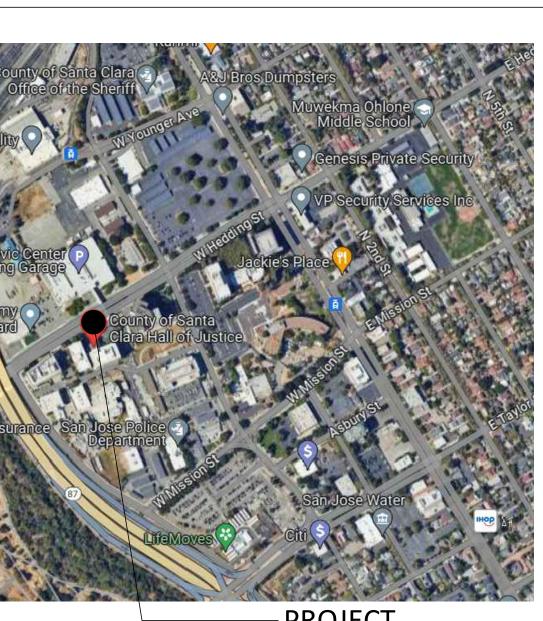

**PROJECT** LOCATION



IENT PROJECT TO INCLUDE:

LOORING FINISHES AT COURTROOM AND REPLACE/REPAIR AUDIENCE SEATING

FINISHES AND SEATING IN THE AUDIENCE AREA.

259-04-026 PQP - PUBLIC/QUASI-PUBLIC 2.905 ac TYPE II А, В 6-STORY EXISTING BUILDING SIZE: 20,473.2 SF 1715 SF FULLY SPRINKLERED

> 2022 CALIFORNIA BUILDING CODE 2022 CALIFORNIA ELECTRICAL CODE 2022 CALIFORNIA MECHANICAL CODE 2022 CALIFORNIA PLUMBING CODE 2022 CALIFORNIA ENERGY CODE 2022 CALIFORNIA FIRE CODE 2022 CALGREEN CODE \* INCLUDING LOCAL CITY ADOPTED CODES & REQUIREMENTS

PLANNING DEPARTMENT BUILDING DEPARTMENT (NOT FOR CONSTRUCTION) SHEET INDEX STAMP GENERAL G0.00 COVER SHEET ALL DESIGNS, DRAWINGS AND WRITTEN MATERIALS G0.10 SPECIFICATION SHEETS INDICATED HEREIN ARE THE WORK AND PROPERTY G0.20 SYMBOLS AND ABBREVIATIONS OF STUDIO G ARCHITECTS. THIS DOCUMENT MAY G0.30 CALGREEN CHECK LIST NOT BE DUPLICATED, REUSED OR DISCLOSED BY ANY METHOD WITHOUT THE WRITTEN CONSENT OF STUDIO:G ARCHITECTS. ALL RIGHTS RESERVED. ARCHITECTURAL REV A0.00 EXISTING SITE PLAN (FOR REFERENCE ONLY) A1.04 OVERALL FLOOR PLAN - 4TH FLOOR A4.14 ENLARGED PLAN A9.74 DETAILS - MISCELLANEOUS & SPECIALTIES 02.0 A10.4 EXISTING PHOTO CONDITIONS 03. 03. DAT SCA PRO DRA JURISDICTION APPROVAL STAMP COVER SHEET SHEET TITLE





### **PROJECT ADDRESS** HALL OF JUSTICE EAST,4TH F,DEPT 30 190 W. HEDDING STREET SAN JOSE, CA 95110

## **TENANT IMPROVEMENT for SUPERIOR COURT OF CALIFORNIA COUNTY OF SANTA CLARA**



VISIONS	
DATE	DESCRIPTION
.02.2024	ISSUED 50% CD FOR PRICING
.01.2024	ISSUED 100% CD FOR PRICING
.08.2024	100% CD FOR CLIENT'S REVIEW

TE	01.04.2024
ALE	AS SHOWN
OJECT ID	2023.205
AWN BY	KN/PT



SHEET NO.

### SPECIFICATIONS

SECTION 01 11 00 - SUMMARY OF WORK

- SEE COVER SHEET G0.00 FOR PROJECT LOCATION AND DESCRIPTION OF SCOPE OF WORK.
- WORK INCLUDES MATERIALS, LABOR, SERVICES, TRANSPORTATION, AND EQUIPMENT NECESSARY TO PERFORM THE WORK AS INDICATED ON THE CONSTRUCTION DOCUMENTS AND SPECIFICATIONS, AND AS NECESSARY TO COMPLETE THE CONTRACT. ITEMS NOTED 'NIC' (NOT IN CONTRACT) WILL BE FURNISHED AND / OR INSTALLED BY OWNER OR UNDER SEPARATE CONTRACT.
- THE GENERAL CONTRACTOR SHALL BE SOLELY AND COMPLETELY RESPONSIBLE FOR CONDITIONS OF THE PREMISES ON WHICH THE WORK IS PERFORMED AND FOR SAFETY OF ALL PERSONS AND PROPERTY ON THE SITE DURING PERFORMANCE OF HIS CONTRACT. THESE REQUIREMENTS SHALL NOT BE LIMITED TO NORMAL WORKING HOURS, BUT SHALL APPLY CONTINUOUSLY.
- THE GENERAL CONTRACTOR SHALL AT ALL TIMES KEEP THE PREMISES FREE OF ACCUMULATIONS OF WASTE MATERIALS OR RUBBISH CAUSED BY HIS OPERATIONS OR OPERATIONS OF SEPARATE CONTRACTORS. GENERAL CONTRACTOR SHALL CONFINE HIS OPERATIONS FOR REMOVAL TO SUCH METHODS AS MAY BE AGREEABLE TO THE OWNER. THE PROJECT SHALL BE LEFT CLEAN AND CLEAR TO THE SATISFACTION OF THE OWNER AND THE DISPOSITION TO ALL SALVAGED MATERIALS IS TO BE CLEARED WITH THE OWNER PRIOR TO REMOVAL. PREMISES TO BE SWEPT CLEAN OF RELATED CONSTRUCTION DEBRIS DAILY.

SECTION 01 23 00 - ALTERNATES

- ALTERNATES ARE PART OF WORK ONLY IF INCLUDED IN THE AGREEMENT.
- IMMEDIATELY FOLLOWING AWARD OF THE CONTRACT, NOTIFY EACH PARTY INVOLVED, IN WRITING, OF THE STATUS OF EACH ALTERNATE. INDICATE IF ALTERNATES HAVE BEEN ACCEPTED, REJECTED, OR DEFERRED FOR LATER CONSIDERATION. INCLUDE A COMPLETE DESCRIPTION OF NEGOTIATED REVISIONS TO ALTERNATES.
- EXECUTE ACCEPTED ALTERNATES UNDER THE SAME CONDITIONS AS OTHER WORK OF THE CONTRACT. COORDINATION: REVISE OR ADJUST AFFECTED ADJACENT WORK TO COMPLETELY INTEGRATE WORK OF ALTERNATE INTO PROJECT.
- 1. INCLUDE AS PART OF EACH ALTERNATE, MISCELLANEOUS DEVICES, ACCESSORY OBJECTS, AND SIMILAR ITEMS INCIDENTAL TO OR REQUIRED FOR A COMPLETE INSTALLATION WHETHER OR NOT INDICATED AS PART OF ALTERNATE.

SECTION 01 25 00 - SUBSTITUTION PROCEDURES

- SUBMIT THREE COPIES OF EACH REQUEST FOR CONSIDERATION. IDENTIFY PRODUCT/FABRICATION/INSTALLATION METHOD TO BE REPLACED. INCLUDE SPECIFICATION SECTION NUMBER, TITLE AND DRAWING NUMBERS AND TITLES. SHOW COMPLIANCE WITH REQUIREMENTS FOR SUBSTITUTIONS.
- PROVIDE STATEMENT INDICATING WHY SPECIFIED PRODUCT OR FABRICATION OR INSTALLATION CANNOT BE PROVIDED, IF APPLICABLE.
- INCLUDE A LIST OF CHANGES OR REVISIONS NEEDED TO OTHER PARTS OF THE WORK THAT WILL BE NECESSARY TO ACCOMMODATE PROPOSED SUBSTITUTION.

SUBMIT REQUESTS FOR SUBSTITUTION IMMEDIATELY ON DISCOVERY OF NEED FOR CHANGE, BUT NOT LATER THAN TIME REQUIRED FOR PREPARATION AND REVIEW OF RELATED SUBMITTALS.

SECTION 01 26 00 - CONTRACT MODIFICATION PROCEDURES

- MINOR CHANGES IN WORK: ARCHITECT WILL ISSUE SUPPLEMENTAL INSTRUCTIONS AUTHORIZING MINOR CHANGES IN THE WORK, NOT INVOLVING ADJUSTMENT TO THE CONTRACT SUM OR THE CONTRACT TIME.
- OWNER INITIATED WORK CHANGE PROPOSAL REQUEST: ARCHITECT WILL ISSUE PROPOSED CHANGES IN WORK THAT INVOLVE ADJUSTMENTS TO CONTRACT SUM OR CONTRACT TIME. CHANGE ORDER PROPOSAL REQUEST ISSUED BY ARCHITECT ARE FOR INFORMATION ONLY, AND ARE NOT INSTRUCTIONS TO STOP WORK OR TO EXECUTE PROPOSED CHANGE.
- CONTRACTOR INITIATED WORK CHANGES PROPOSAL: WHEN UNFORESEEN CONDITIONS REQUIRE MODIFICATIONS TO THE CONTRACT, CONTRACTOR MAY PROPOSE CHANGES BY SUBMITTING A REQUEST FOR A CHANGE TO ARCHITECT AND OWNER. CHANGES ORDERS: CONTRACTOR SHALL BE DIRECTED TO PROCEED WITH WORK UPON OWNER'S APPROVAL OF CHANGE ORDER PROPOSAL.

SECTION 01 30 00 - ADMINISTRATIVE REQUIREMENTS

- CONSTRUCTION SCHEDULES: PROVIDE CONSTRUCTION SCHEDULE FOR DESIGN TEAM AND OWNER REVIEW AND TO MAINTAIN ENTIRE TEAM UP TO DATE ON CONSTRUCTION ACTIVITIES. SHOW COMPLETE SEQUENCE OF CONSTRUCTION BY ACTIVITY, IDENTIFYING WORK OF SEPARATE STAGES AND LOGICALLY GROUPED
- ACTIVITIES. 2. SHOW MILESTONES: NOTICE TO PROCEED, SUBSTANTIAL COMPLETION, FINAL COMPLETION, ETC.
- 3. UPDATES: AT WEEKLY INTERVALS, ISSUED TWO DAYS BEFORE EACH PROGRESS MEETING.
- PRODUCT DATA: COLLECT INFORMATION INTO A SINGLE SUBMITTAL FOR EACH ELEMENT OF CONSTRUCTION AND TYPE OF PRODUCT OR EQUIPMENT. INCLUDE MANUFACTURE'S CATALOG CUTS AND PRODUCT SPECIFICATIONS, STANDARD COLOR CHARTS, STATEMENT OF COMPLIANCE WITH SPECIFIED REFERENCED STANDARDS, TESTING DATA BY RECOGNIZED TESTING AGENCY, AND SAFETY DATA SHEETS. MARK EACH SUBMITTAL TO SHOW WHICH PRODUCTS ARE APPLICABLE. LABEL EACH SUBMITTAL WITH PROJECT NAME, SPECIFICATION NUMBER, DATE, AND CONTRACTOR'S APPROVAL STAMP.
- SHOP DRAWINGS: PROVIDE SHOP DRAWINGS, MEETING INDUSTRY STANDARDS, AT APPROPRIATE SCALE FOR THE WORK AND FOR THE REVIEW. SHOP DRAWINGS MUST BE SPECIFIC TO PROJECT AND NOT EDITED COPIES OF ARCHITECT'S DRAWINGS. REVIEW BY ARCHITECT IS FOR DESIGN INTENT ONLY. PROPER FIT UP, COORDINATION OF WORK, CONSTRUCTION TECHNIQUES, MATERIALS, AND WORK REQUIRED BY CONTRACT DOCUMENTS ARE THE RESPONSIBILITY OF THE CONTRACTOR.
- SAMPLES: SUBMIT SAMPLES FOR REVIEW OF KIND, COLOR, PATTERN, TEXTURE OR REQUIRED CHARACTERISTIC. PERMANENTLY ATTACHED LABEL ON ONE SIDE OF SAMPLES LISTING: PROJECT NAME, SUBMITTAL NUMBER, PRODUCT NAME, MANUFACTURER, SAMPLE SOURCE, NUMBER. AND TITLE OF APPLICABLE SPECIFICATION SECTION.
- 1. SUBMIT FOR INITIAL SELECTION MANUFACTURER'S COLOR CHARTS/COLLECTIONS SHOWING THE FULL RANGE OF COLORS, TEXTURES, AND PATTERNS AVAILABLE. SUBMIT FOR VERIFICATION FULL SIZE UNITS OR OF SIZE INDICATED, PREPARED FROM SAME MATERIAL TO BE USED IN WORK, FINISHED IN THE MANNER SPECIFIED, IDENTICAL TO THAT PROPOSED FOR USE.
- ATTIC STOCK: FURNISH EXTRA MATERIALS THAT MATCH AND FROM THE SAME PRODUCTION RUN AS PRODUCTS INSTALLED. FURNISH QUANTITY OF FULL-SIZE UNITS EQUAL TO (5) PERCENT OF AMOUNT OF EACH INSTALLED TYPE, COMPOSITION, COLOR, PATTERN, AND SIZE INDICATED.
- 1. SEE FINISH PLAN GENERAL NOTES FOR WHICH PRODUCTS TO PROVIDE ATTIC STOCK OF AND IF MORE OR LESS PERCENTAGE IS REQUIRED.
- SUBMITTALS: SUBMIT A SCHEDULE OF SUBMITTALS, ARRANGED IN CHRONOLOGICAL ORDER BY DATES REQUIRED BY CONSTRUCTION SCHEDULE. INCLUDE TIME REQUIRED FOR REVIEW, ORDERING, MANUFACTURING, FABRICATION, & DELIVERY WHEN ESTABLISHING DATES. INCLUDE ADDITIONAL TIME REQUIRED FOR MAKING CORRECTIONS OR REVISIONS TO SUBMITTALS NOTED BY ARCHITECT AND CONSTRUCTION MANAGER, AND ADDITIONAL TIME FOR HANDLING & REVIEWING SUBMITTALS REQUIRED BY THOSE CORRECTIONS. DEFERRED SUBMITTALS: SUBMIT LIST OF DEFERRED SUBMITTALS. INCLUDE DATE OF SUBMITTAL, REASON FOR DEFERMENT, AND IMPACT ON OTHER WORK. DEFERRED SUBMITTALS SHALL BE SUBMITTED TO THE ARCHITECT AND/OR ENGINEER FOR REVIEW, APPROVAL, AND FORWARDING TO AHJ. DEFERRED SUBMITTAL ITEMS SHALL NOT BE INSTALLED UNTIL REVIEWED AND APPROVED BY AHJ. ANY CHANGES TO THE APPROVED DOCUMENTS REQUIRED BY A DEFERRED SUBMITTAL WILL BE SUBMITTED TO THE AHJ AS A REVISION, WITH CHANGES

SECTION 01 70 00 - EXECUTION

CLOUDED.

- EXAMINATION: BEFORE PROCEEDING WITH EACH COMPONENT OF THE WORK, EXAMINE SUBSTRATES, AREAS, AND CONDITIONS, WITH INSTALLER OR APPLICATOR PRESENT WHERE INDICATED, FOR COMPLIANCE WITH REQUIREMENTS FOR INSTALLATION TOLERANCES AND OTHER CONDITIONS AFFECTING PERFORMANCE. SUBMIT WRITTEN REPORT LISTING CONDITIONS DETRIMENTAL TO THE PERFORMANCE OF THF WORK
- 1. EXAMINE ROUGH-IN FOR MECHANICAL AND ELECTRICAL SYSTEMS TO VERIFY ACTUAL LOCATIONS OF CONNECTIONS BEFORE EQUIPMENT AND FIXTURE INSTALLATION.
- EXAMINE WALLS, FLOORS, AND CEILINGS FOR SUITABLE CONDITIONS WHERE PRODUCTS AND SYSTEMS ARE TO BE INSTALLED. 3. VERIFY COMPATIBILITY WITH AND SUITABILITY OF SUBSTRATES, INCLUDING COMPATIBILITY WITH EXISTING FINISHES OR PRIMERS.
- PROCEED WITH INSTALLATION ONLY AFTER UNSATISFACTORY CONDITIONS HAVE BEEN CORRECTED. PROCEEDING WITH WORK INDICATES ACCEPTANCE OF SURFACES AND CONDITIONS.
- THE CONTRACTOR WILL PROVIDE ALL WORK AND MATERIALS IN ACCORDANCE WITH AUTHORITIES HAVING JURISDICTION. INSTALLATION:
- 1. LOCATE THE WORK AND COMPONENTS OF THE WORK ACCURATELY, IN CORRECT ALIGNMENT AND ELEVATION, AS INDICATED. 2. COMPLY WITH MANUFACTURER'S WRITTEN INSTRUCTIONS AND RECOMMENDATIONS FOR INSTALLING PRODUCTS IN APPLICATIONS INDICATED.
- 3. CONTRACTOR TO PERFORM MOISTURE TESTING PRIOR TO THE ORDER OF MATERIALS FOR VERIFICATION OF COMPLIANCE WITH MANUFACTURER'S WARRANTIES. 4. INSTALL PRODUCTS AT THE TIME AND UNDER CONDITIONS THAT WILL ENSURE SATISFACTORY. MAINTAIN CONDITIONS REQUIRED FOR
- PRODUCT PERFORMANCE UNTIL SUBSTANTIAL COMPLETION. 5. SEQUENCE THE WORK AND ALLOW ADEQUATE CLEARANCES TO ACCOMMODATE MOVEMENT OF CONSTRUCTION ITEMS ON-SITE AND PLACEMENT IN PERMANENT LOCATIONS
- 6. TOOLS AND EQUIPMENT: SELECT TOOLS OR EQUIPMENT THAT MINIMIZE PRODUCTION OF EXCESSIVE NOISE LEVELS. 7. ATTACHMENT: PROVIDE BLOCKING AND ATTACHMENT PLATES AND ANCHORS AND FASTENERS OF ADEQUATE SIZE AND NUMBER TO
- SECURELY ANCHOR EACH COMPONENT IN PLACE, ACCURATELY LOCATED AND ALIGNED WITH OTHER PORTIONS OF THE WORK. 8. JOINTS: MAKE JOINTS OF UNIFORM WIDTH. FIT EXPOSED CONNECTIONS TOGETHER TO FORM HAIRLINE JOINT.
- CLEAN PROJECT SITE AND WORK AREAS DAILY. MAINTAIN PROJECT SITE FREE OF WASTE MATERIALS AND DEBRIS.

SECTION 01 73 29 - CUTTING & PATCHING

- CUTTING & PATCHING: COMPLY WITH REQUIREMENTS FOR AND LIMITATIONS ON CUTTING & PATCHING OF CONSTRUCTION ELEMENTS. DO NOT CUT AND PATCH STRUCTURAL ELEMENTS IN A MANNER THAT COULD CHANGE THEIR LOAD-CARRYING CAPACITY OR INCREASE DEFLECTION. DO NOT CUT AND PATCH OPERATING ELEMENTS AND RELATED COMPONENTS
- REMOVE, REPLACE, PATCH, & REPAIR MATERIALS & SURFACES CUT OR DAMAGED DURING INSTALLATION OR CUTTING & PATCHING OPERATIONS. BY METHODS & WITH MATERIALS SO AS NOT TO VOID EXISTING WARRANTIES. USE MATERIALS FOR PATCHING IDENTICAL TO EXISTING MATERIALS. FOR EXPOSED SURFACES, IF IDENTICAL MATERIALS ARE UNAVAILABLE OR CANNOT BE USED, USE MATERIALS THAT, WHEN INSTALLED, WILL PROVIDE A MATCH ACCEPTABLE TO ARCHITECT FOR THE VISUAL &
- FUNCTIONAL PERFORMANCE OF IN-PLACE MATERIALS. REMOVE, REPLACE, PATCH, & REPAIR MATERIALS & SURFACES CUT OR DAMAGED DURING INSTALLATION OR CUTTING & PATCHING OPERATIONS, BY METHODS & WITH MATERIALS SO AS NOT TO VOID EXISTING WARRANTIES.

### SECTION 01 77 00 - CLOSEOUT PROCEDURES

- ITEMS APPLYING TO EACH SPACE BY MAJOR ELEMENT
- B. SUBMIT CLOSEOUT ITEMS REQUIRED IN OTHER SECTIONS.
- D. SUBMIT SUSTAINABLE DESIGN SUBMITTALS NOT PREVIOUSLY SUBMITTED.
- CLEAN LUMINARIES, LAMPS, GLOBES, AND REFLECTORS TO FUNCTION WITH FULL EFFICIENCY. REPLACE BULBS THAT ARE DIM OR BURNED
- OUT. G. CLEAN STRAINERS, TOILETS, SINKS, AND DRINKING FOUNTAINS.
- TOUCH UP OR REPAIR FINISHES.

- 1. ENERGY EFFICIENCY
- 2. WATER EFFICIENCY AND CONSERVATION
  - 4. MECHANICAL EQUIPMENT POLLUTION CONTROL.
  - EMISSIONS INCLUDING a. ADHESIVES, SEALANTS, AND CAULKS
  - b. PAINTS AND COATINGS
  - d. RESILIENT FLOORING SYSTEMS e. COMPOSITE WOOD PRODUCTS
- C. SUBMITTALS:
- CONSTRUCTION INDOOR AIR QUALITY MANAGEMENT 1. EPA'S "TESTING FOR INDOOR AIR QUALITY.
- F. "CALGREEN MANDATORY MEASURES CHECKLIST.

SECTION 02 41 19 - SELECTIVE DEMOLITION

- C. ARRANGE SELECTIVE DEMOLITIONS SCHEDULE SO AS NOT TO INTERFERE WITH OWNER'S OPERATIONS.
- PLANS INDICATION PROPOSED MEASURES AND LOCATIONS.

- INDICATED.
- I. CLEAN ADJACENT SURFACES OF DUST AND DEBRIS CAUSED BY SELECTIVE DEMOLITION OPERATIONS.
- JURISDICTION.

SECTION 09 65 13 - RESILIENT BASE AND ACCESSORIES

- A. SCOPE OF WORK: INSTALLATION OF THERMOSET RUBBER BASE.
- B. SUBMITTALS: PRODUCT DATA FOR EACH TYPE OF PRODUCT.
- D. QUALITY ASSURANCE: QUALIFICATIONS FOR MANUFACTURER, INSTALLER.
- INSTRUCTIONS.
- F. PRODUCTS: SEE FINISH SCHEDULE
- PATCHING COMPOUND.
- SECTION 09 68 00 CARPETING
- A. SCOPE OF WORK: INSTALLATION OF CARPET PER FINISH PLANS.

- E. QUALITY ASSURANCE: QUALIFICATIONS FOR MANUFACTURER, INSTALLER.
- F. WARRANTY: MANUFACTURER'S SPECIAL WARRANTY. G. PERFORMANCE CHARACTERISTICS:
- INSTRUCTIONS. KEEP CARPET MATERIALS IN CONTROLLED ENVIRONMENT UNTIL INSTALLATION.
- PRODUCTS: SEE FINISH SCHEDULE
- AND PREPARING SUBSTRATES.
- PRODUCTION RUN AND DYE LOT.

LOCATIONS.

INSTRUCTIONS

COLORS: REFER TO FINISH SCHEDULE.

IN SHARP LINES & COLOR BREAKS.

### A. PREPARE AND SUBMIT CONTRACTOR'S LIST OF INCOMPLETE ITEMS (PUNCH LIST). ORGANIZE LIST OF SPACES IN SEQUENTIAL ORDER, STARTING WITH EXTERIOR AREAS FIRST AND PROCEEDING FROM LOWEST FLOOR TO HIGHEST FLOOR, LISTED BY ROOM OR SPACE NUMBER. ORGANIZE

C. SUBMIT PROJECT WARRANTIES. ASSEMBLE COMPLETE WARRANTY AND BOND SUBMITTAL PACKAGE INTO A SINGLE ELECTRONIC PDF FILE.

COMPLETE FINAL CLEANING. USE CLEANING MATERIALS AND AGENTS RECOMMENDED BY MANUFACTURER OR FABRICATOR OF THE SURFACE TO BE CLEANED. DO NOT USE CLEANING AGENTS THAT ARE POTENTIALLY HAZARDOUS TO HEALTH OR PROPERTY OR THAT MIGHT DAMAGE FINISHED SURFACES. USE PRODUCTS THAT COMPLY WITH THE CALIFORNIA CODE OF REGULATIONS MAXIMUM ALLOWABLE VOC LEVELS.

H. CLEAN DUCTS, BLOWERS, AND COILS. INSTALL NEW FILTERS IF UNITS WERE OPERATED WITHOUT FILTERS DURING CONSTRUCTION OR THAT DISPLAY CONTAMINATION WITH PARTICULATE MATTER ON INSPECTION.

SECTION 01 85 15 - CALGREEN NON-RESIDENTIAL MANDATORY

A. SUMMARY: COMPLY WITH SPECIFIC CALGREEN REQUIREMENTS FOR NONRESIDENTIAL PROJECTS AS APPLICABLE TO PROJECT. B. REQUIREMENTS: CONSTRUCTION TEAM IS REQUIRED TO REVIEW NONRESIDENTIAL CALGREEN REQUIREMENTS RELATIVE TO THE FOLLOWING:

3. MATERIAL CONSERVATION AND RESOURCE EFFICIENCY: CONSTRUCTION WASTE.

5. FINISH MATERIAL POLLUTION CONTROL: COMPLY WITH CALGREEN REQUIREMENTS FOR VOLATILE ORGANIC COMPOUND (VOC)

c. CARPET SYSTEMS, INCLUDING CARPET, CARPET CUSHION, AND ADHESIVES

1. SUSTAINABLE DESIGN DOCUMENTATION SUBMITTALS: PRODUCT DATA, RECEIPTS, CERTIFICATION LETTERS, CHAIN- OF-CUSTODY CERTIFICATES, AND OTHER DOCUMENTATION NEEDED TO SHOW COMPLIANCE WITH REQUIREMENTS. 2. INFORMATIONAL SUBMITTALS: PROJECT COST DATA, SUSTAINABLE DESIGN ACTION PLAN, AND SUSTAINABLE DESIGN PROGRESS REPORTS.

A. CONDUCT SELECTIVE DEMOLITION SO OWNER'S OPERATIONS WILL NOT BE DISRUPTED.

B. NOTIFY ARCHITECT OF DISCREPANCIES BETWEEN EXISTING CONDITIONS AND DRAWINGS BEFORE PROCEEDING.

D. PROVIDE TEMPORARY MEASURES TO PROTECT INDIVIDUALS AND PROPERTY FOR INJURY, DUST, AND NOISE CONTROL. SUBMIT REPORT AND

EXISTING SERVICES/SYSTEMS TO REMAIN: MAINTAIN SERVICES/SYSTEMS INDICATED TO REMAIN AND PROTECT THEM AGAINST DAMAGE. EXISTING SERVICES/SYSTEMS TO BE REMOVED, RELOCATED, OR ABANDONED: LOCATE IDENTIFY, DISCONNECT, AND SEAL OR CAP OFF UTILITY SERVICES AND MECHANICAL/ELECTRICAL SYSTEMS SERVING AREAS TO BE SELECTIVELY DEMOLISHED.

G. REMOVE EXISTING WORK AS INDICATED AND REQUIRED TO ACCOMPLISH NEW WORK. REMOVE EXISTING SYSTEMS AND EQUIPMENT AS

REMOVE DEMOLITION WASTE FROM PROPERTY. COMPLY WITH HAULING AND DISPOSAL REGULATIONS OF AUTHORITIES HAVING

SAMPLES: PROVIDE SAMPLES OF EXPOSED PRODUCT OF EACH COLOR & FINISH REQUIRED.

PROJECT CONDITIONS: MAINTAIN ENVIRONMENTAL CONDITIONS WITHIN LIMITS RECOMMENDED BY MANUFACTURER WRITTEN

### PERFORMANCE REQUIREMENTS: FIRE TEST RESPONSE CHARACTERISTICS AS DETERMINED BY TESTING IDENTICAL PRODUCTS ACCORDING TO ASTM E648 OR NFPA 253 BY A QUALIFIED TESTING AGENCY. CRITICAL RADIANT FLUX CLASSIFICATION: CLASS 1, NOT LESS THAN 0.45 W/SQ.

PREPARATION: PREPARE SUBSTRATES ACCORDING TO MANUFACTURER'S WRITTEN INSTRUCTIONS TO ENSURE ADHESION OF RESILIENT PRODUCTS. PREPARE CONCRETE SUBSTRATES ACCORDING TO ASTM F710. PERFORM ANHYDROUS CALCIUM CHLORIDE TEST ASTM F1869 AND RELATIVE HUMIDITY TEST ASTM F21700. FILL CRACKS, HOLES, AND DEPRESSIONS IN SUBSTRATES WITH TROWELABLE LEVELING &

INSTALLATION: COMPLY WITH MANUFACTURER'S WRITTEN INSTRUCTIONS FOR INSTALLATION.

FURNISH EXTRA MATERIALS THAT MATCH AND ARE FROM THE SAME PRODUCTION RUN AS INSTALL MATERIALS & ARE PACKAGED, LABELED.

B. SUBMITTALS: PRODUCT DATA. PRODUCT TEST REPORTS. MAINTENANCE DATA. SUBMIT CARPET SEAMING DIAGRAM FOR APPROVAL. SHOP DRAWINGS SHOWING COLUMNS, DOORWAYS, ENCLOSING WALLS, OR PARTITIONS, BUILT IN CABINETS, AND CUT OUT LOCATIONS. INDICATE SUBFLOOR, SEAM LOCATIONS, PILE DIRECTION. BORDER TYPES & LOCATIONS, TILE PATTERN LAYOUT, TRANSITION DETAILS. D. SAMPLES: PROVIDE SAMPLES OF EXPOSED PRODUCT OF EACH COLOR & TEXTURE REQUIRED.

1. CRITICAL RADIANT FLUX CLASSIFICATION: NOT LESS THAN [0.45 W/SQ. CM] [0.22 W/SQ. CM] ACCORDING TO NFPA 253.

H. PROJECT CONDITIONS: MAINTAIN ENVIRONMENTAL CONDITIONS WITHIN LIMITS RECOMMENDED BY MANUFACTURER WRITTEN

PREPARATION: COMPLY WITH CARPET AND RUG INSTITUTE CRI 104 & WITH MANUFACTURER'S WRITTEN INSTRUCTIONS FOR EXAMINING

INSTALLATION: COMPLY WITH MANUFACTURER'S WRITTEN INSTRUCTIONS FOR INSTALLATION. USE INSTALLATION METHOD & MATERIALS APPROPRIATE TO THE SUBSTRATE. MAINTAIN DYE LOT INTEGRITY. MAINTAIN PILE DIRECTION PATTERNS. PROVIDE ATTIC STOCK FROM SAME

### SECTION 09 91 23 - INTERIOR PAINTING

A. SCOPE OF WORK: PAINTING OF PARTITIONS, DOORS & FRAMES. REFER TO FINISH SCHEDULE AND FINISH PLAN FOR PRODUCTS AND

B. MATERIALS: PRIMERS, WATER BASED FINISH COATINGS, SOLVENT BASED COATINGS, FLOOR SEALERS AND PAINTS.

C. SUBMITTALS: PRODUCT DATA FOR EACH TYPE OF PRODUCT, INCLUDING PREPARATION REQUIREMENT AND APPLICATION INSTRUCTIONS. D. SAMPLES FOR EACH TYPE OF TOPCOAT PAINT SYSTEM AND IN EACH COLOR AND GLOSS SPECIFIED. PRODUCT SCHEDULE TO USE SAME DESIGNATION INDICATED ON DRAWINGS.

E. ATTIC STOCK: FURNISH EXTRA MATERIALS FROM THE SAME PRODUCT RUN THAT MATCH PRODUCTS INSTALLED.

F. QUALITY ASSURANCE: MOCKUPS OF EACH PAINT SYSTEM INDICATED; EACH COLOR & FINISH SELECTED. G. PROJECT CONDITIONS: MAINTAIN ENVIRONMENTAL CONDITIONS WITHIN LIMITS RECOMMENDED BY MANUFACTURER'S WRITTEN

PRODUCTS: MATERIALS USED WITHIN FACH PAINT SYSTEM SHALL BE COMPATIBLE WITH ONE ANOTHER AND SUBSTRATES INDICATED, UNDER CONDITIONS OF SERVICE AND APPLICATION, BASED ON TESTING AND FIELD EXPERIENCE.

EXAMINATION: VERIFY SUITABILITY OF SUBSTRATES, INCLUDING SURFACE CONDITIONS AND COMPATIBILITY, WITH EXISTING FINISHES AND PRIMERS. CLEAN SUBSTRATES OF SUBSTANCES THAT COULD IMPAIR BOND OF PAINT INCLUDING DUST, DIRT, OIL, GREASE, AND INCOMPATIBLE PAINTS & ENCAPSULANTS. PROCEED ONLY AFTER UNSATISFACTORY CONDITIONS HAVE BEEN CORRECTED. APPLICATION OF COATING INDICATES ACCEPTANCE OF SURFACES & CONDITIONS. PREPARATION: COMPLY WITH MANUFACTURER'S WRITTEN INSTRUCTIONS & RECOMMENDATIONS. REMOVE HARDWARE, ACCESSORIES,

COVER PLATES, & SIMILAR ITEMS REMOVABLE THAT ARE NOT TO BE PAINTED. AFTER PAINT APPLICATION, REINSTALL ITEMS THAT WERE REMOVED, USING WORKERS SKILLED IN THE TRADE INVOLVED.

INSTALLATION: APPLY PAINTS ACCORDING TO MANUFACTURER'S WRITTEN INSTRUCTION. APPLY PAINTS TO PRODUCE SURFACE FILMS WITHOUT CLOUDINESS, SPOTTING, LAPS, BRUSH MARKS, ROLLER TRACKS, RUNS, SAGS, ROPINESS, OR OTHER SURFACE IMPERFECTIONS. CUT

M. PROTECTION: PROTECT WORK OF OTHER TRADES AGAINST DAMAGE FROM PAINT APPLICATION, CORRECT DAMAGE TO WORK OR OTHER TRADES BY CLEANING, REPAIRING, REPLACING, & REFINISHING, AS APPROVED BY ARCHITECT, AND LEAVE IN AN UNDAMAGED CONDITION.

### SPECIFICATIONS - CARPET

### ShawContract<sup>®</sup>

### CARPET TILE

For best results review the product and product specific guidelines prior to indoor responsible for improper installation and installation of visual manufacturing defea guidelines may result in limiting warranty coverage. Contact Shaw Technical Suppo additional information.

CONDITION YOUR SITE AND • HVAC System: Must be operational, maintaining t

SUBFLOOR TESTING

GUIDELINES

- hours prior to, during and after installation. • Temperature: The installation site, carpet and ad <sup>o</sup> F and 95 <sup>o</sup> F. Adhesives will not function properly temperatures outside this range. Do not begin the temperature is below 50 ° F.
- Humidity: The installation site's ambient relative h 40%.
- Moisture Testing: Conduct subfloor moisture test ASTM F-2170 (in-situ Relative Humidity) and/or AST Calcium Chloride).
- pH / Alkalinity: Conduct ASTM F-3441 pH/Alkalinity

Shaw recommends moisture testing prior to starting If excessive moisture is present, the general contract be advised of the readings, and a decision made re

moisture or continue the installation.

The following chart breaks down the carpet backing installation, the required subfloor testing requirement adhesive for each:

Carpet Tile Backing		Installation Area		Testing Requiremen		
EcoWorx E	60	Below/On- grade/Above		Moisture an pH		
StrataWor	x	Below/On- grade/Above		Moisture an pH		
EcoWorx	Below/On- grade Above Grade			Moisture ar pH		
EcoWorx				No Testing Required		
EcoLogix	Ab	ove Grade		No Testing Required		
EcoWorx		n or Below ade *	No Testing Required			
EcoLogix		n or Below ade *		o Testing equired		
* LokDots a	nd 4	4151 are moisture	e re	sistant produ		

LokDots and 4151 are moisture resistant products eliminate moisture.

SURFACE PREPARATION

PREPARE EXISTING

LAY OUT YOUR SITE

APPLY ADHESIVE

ADHESIVE

 Substrate must be structurally sound, clean, level Substrate must be free of dust, dirt, oil, grease, per sealers, adhesives, loosely bonded toppings, loose substance or condition that may prevent or reduc

- Fill depressions or cracks with a cementitious pate that meet or exceed Shaw Industries maximum m requirements. Use of gypsum-based patching and which contain Portland or high alumina cement an compressive strength of 3,000 psi are acceptable
- For cracks or saw cuts deeper than 1", follow the p instructions for Shaw QuikFill. QuikFill is a 2-part ur prevents future damage from moisture penetrati slab that may damage or breakdown adhesives of compounds For chemically abated substrates, ensure the property
- been taken to remove any residual abatement ch Green sweeping compounds can be used but must immediately.
- For dusting / powdering / porous concrete / lightv latex primer such as 9050.
- For patches / levelers prime with a latex primer su If installed over existing resilient flooring (one layer
- secure to the subfloor. Strip any wax from the sur Wood Subfloors must be Wood Association Appro
- primer such as 9050. Raised Access Flooring panels must be smooth, le
- material that will affect the adhesive bond. Carp offset from access panel seams. Gaps between 1/16" or (1.6mm).

Note: Do not sand or scrape Vinyl Asbestos tile (VAT to abatement procedures or precautions in accorde codes. Shaw Industries makes no claims as to the ad procedure as a mitigation method in lieu of asbesto responsibility if any loose asbestos containing floori removal of a Shaw Industries commercial tile.

Caution: Do not allow cutback asphaltic adhesive of adhesive to come in contact with new adhesives. A result. If this situation arises, contact Shaw Technic

- Remove existing adhesives to prevent adhesive in and bonding issues.When installing Ecologix backe adhesive is not necessary as long as the existing a The top ridges of existing adhesive should be flat adhesive does not interfere with adhesion of new
- backing. Existing ridges should be no higher than 1 Cutback Adhesive: Wet scrape the adhesive, reduced residue and encapsulate with a product such as N
- Do not use adhesive removers, they will adversely and product installed.
- Start the carpet tile installation as near to the cell and position it to use the largest perimeter cut til Snap a chalk line parallel to one major wall bisection be necessary to offset the center chalk line to as will be a least half the size.
- Snap a second chalk line from the starting point c a 3-4-5 or 6-8-10 triangle or larger on the room size Meters or feet may be used to lay out the triangle
- Use a full spread adhesive application. A premium pressure sensitive adhesive is recommendation Use a 3/8" nap paint roller or a 1/16" x 1/32" x 5/64" using a 1/16" x 1/32" x 5/64" U-notch trowel to instal application method will Increase the overall bond
- ease of removing and replacing tiles. • Allow the adhesive to dry completed before insta Installing into wet adhesive will result in a permane


Adhesive	CaCl Limit	RH L
4151	10 lbs.	ę
3000	10 lbs.	ę
5000	15 lbs.	ę
LokDots*	N/A	I
LokWorx Tabs*	5 lbs.	8
EcoLogix ES (mill applied)	10 lbs.	ę
EcoWorx ES (mill applied)	5 lbs.	8

Installation		* LokDots is not a moisture remediation solution. If visible moisture is present or there are known moisture issues such as hydrostatic pressure, additional steps should be taken to address the moisture issues. For older slabs or slabs with a prior history of moisture related issues, Shaw Technical Support recommends moisture mitigation in the form of a 2-part epoxy system, such as MoistureTEK. For newer slabs with an intact moisture retarder, initial moisture levels should recede over time.	99 BASSETT ST. SUITE SAN JOSE, CA 95 T:408.283.0	TUDIO
or installation. Shaw will not be fected tiles. Failure to follow oport at 800.471.7429 for		* LokWorx Tabs conduct Relative Humidity and pH testing. In addition, concrete substrate moisture must be tested by the current version of ASTM F1869 anhydrous calcium chloride test. For concrete with a prior history of uncorrected moisture conditions or problems involving higher moisture levels, treat the concrete with a moisture mitigation product, prior to adhesive application.	Ñ	ARCHITECTS
g the following conditions 24 adhesive must be between 50 erly when exposed to the installation if the subfloor		Install each full carton and complete an entire pallet before starting another pallet to minimize product variation. All Shaw carpet tiles have directional arrows on the back of the carpet tile to help facilitate the installation method for that product. The numbers within the arrows are for manufacturing purposes only and are not related to the installation.		TICE EAST,4TH F,DEPT 30
re humidity must not fall below esting in accordance to the ASTM F-1869 (Anhydrous hity testing. ing the installation. gractor or building owner must		<ul> <li>Begin the installation at the intersection of the two chalk lines. Continue until you complete one quadrant.</li> <li>Proceed to adjoining quadrants until all four quadrants have been completed. Large areas may require additional chalk lines bisecting the original four quadrants.</li> <li>Install the carpet tile using the pyramid technique. This will provide alignment checks during the installation. If the edges do not align and misalignment is noted, stop the installation and determine where the misalignment started and correct.</li> </ul>		190 W. HEDDING STREET SAN JOSE, CA 95110
regarding how to address the king system, grade of ments and the recommended		<ul> <li>Slide carpet tile into positions to prevent yarn from being trapped at the seams. Trapped yarn can adversely affect the appearance of the installation.</li> <li>EcoWorx ES and EcoLogix ES are manufactured with mill applied adhesive. For these products, remove the release liner to expose the adhesive and install the carpet tile.</li> </ul>		TENANT IMPROVEMENT for COURT OF CALIFORNIA
Adhesive Recommendations ES (mill applied)		<ul> <li>Tiles must fit snugly, but not be compressed. Press the entire surface of the tile to ensure adhesion.</li> <li>After installation, roll the entire installation with a 75 lb or greater roller to assure proper adhesion to the substrate.</li> </ul>		COURT OF CA
LokDots,LokWorx Tabs,3000,5000,4151 LokWorx Tabs,3000,5000,4151 LokDots,3000,5000,4151		<ul> <li>Flatwire cables should be installed on top of the adhesive and centered underneath the carpet tile for better seam quality.</li> <li>Edge Trimming <ul> <li>Measure and cut tile from the back using a straight edge. Ensure directional arrows are properly aligned with the installation.</li> <li>Or allow tile to cove up the wall and cut the carpet tile with a carpet knife, wall trimmer or similar too.</li> <li>Do not compress.</li> </ul> </li> </ul>	COD' SUPERIO	HORNIA - Part
3000,5000,4151,ES (mill applied) LokDots * 4151*, ES (mill applied) cts; however, they do not	POST INSTALLATION CARE AND PROTECTION	<ul> <li>Place plywood over the carpet when heavy objects are moved.</li> <li>Use protective chair mats under chairs and castors. This will prevent excessive wear to the face of the carpet and possible transfer of the pressure sensitive adhesive to the back of the carpet.</li> <li>Non-staining building material paper can be placed of the carpet tile to protect it if additional building construction activity is taking place.</li> <li>Do not use plastic sheeting. This will trap moisture.</li> </ul>		OFSANTA
vel and dry. 2, paint, curing agents, concrete		For best results, temperatures should remain above 50F and ambient humidity should not fall below 40%.		
ose particles and any other duce adhesion. patching / leveling compound n moisture level and pH and/or leveling compounds	SPECIFICATIONS - WO			
and meet or exceed the ble. he preparation and application t urethane treatment that rating to the surface of the es or unapproved patching	GUI	DE SPECIFICATIONS - BENCHES SAUDER MANUFACTURING CO.		RAWINGS AND WRITTEN MATERIALS
proper cleaning methods have t chemicals. must be swept and removed	1.0 GENERAL	ARCHBOLD, OH	OF STUDIO G A NOT BE DUPLI ANY METHOD W	EIN ARE THE WORK AND PROPERTY RCHITECTS. THIS DOCUMENT MAY CATED, REUSED OR DISCLOSED BY /ITHOUT THE WRITTEN CONSENT OF
htweight concrete prime with a	1.1 DESCRIPTION Bench Body shall be m		STUDIO:G AR	CHITECTS. ALL RIGHTS RESERVED.
r such as 9050.	Bench End shall be Sau		REVISIONS	
ayer only), all tiles must be surface. proved and primed with a latex		ion: Manufacturer shall been regularly engaged in the manufacture of similar items y (20) years, and shall have a history of successful production acceptable to the	DATE 02.02.2024	DESCRIPTION ISSUED 50% CD FOR PRICING
n, level, secure and free of any arpet tiles must be installed en panels must not exceed	1.3 SUBMITTALS A. Bench manufacture stain/finish samples B. Bench manufacture	r or manufacturer's rep shall submit product data, shop drawings, fabric samples, and upon request, prior to fabrication of Benches. r or manufacturer's rep shall field measure project and generate as-built, computer n layouts for final approval prior to fabrication.	03.01.2024 03.08.2024	ISSUED 100% CD FOR PRICING 100% CD FOR CLIENT'S REVIEW
VAT) without proper attention ordance with all state and local e acceptability of this estos removal; and accepts no poring are affected upon	1.4 DELIVERY, STORAGE, C. Bench manufacture any storage or hand D. Bench manufacture Benches, using fact			
e or any other non-approved . An installation failure could nical Support. e incompatability /reactions	2.0 PRODUCTS 2.1 ACCEPTABLE MANUFA Sauder Manufacturing ( 930 W Barre Rd. P.O. Box 230 Archbold, OH 43502			
cked tiles, removal of existing ng adhesive is dry and tacky. lattened so the existing new adhesive and Ecologix an 1/32". educe to a well bonded	800-537-1530 2.2 MATERIALS & CONSTR A. Bench Back: Back s nominally ½" plyw premium Sauder st standard wood spe	hall be contoured for comfort, and shall be of 5-ply construction, with a core of ood, two plys crossband of 1/8" hardboard (64.2 lb density), with one ply plain sliced andard wood specie on both faces. The bench back cap shall be 5/4 premium Sauder cie, finger jointed before being molded to obtain required lengths. The cap shall be	DATE SCALE PROJECT ID	01.04.2024 AS SHOWN 2023.205
as MRP. Sely affect the new adhesive center of the room as possible	support molding fo B. Bench Seat: 5-ply o with two plys cross	onstruction, shaped to body contour. Core material shall be nominally ½" plywood, band of 1/8" hardboard (64.2 lb density), with one ply plain sliced premium Sauder	DRAWN BY	KN/PT
t tile. ecting the starting point. It may assure that the perimeter tile	lumber edge band C. Intermediate suppo	cie on top faces, and continuous balance sheet of bottom face. An integral solid shall be laminated into the 5-ply seat for screw-holding at back-to-seat joint. orts shall extend the full height of the bench back to the cap, and shall be 1 ½″ thick.		
nt at a 90 <sup>0</sup> to the first line. Use n size to verify squareness. ngle in these proportions.	D. Bench Ends: Const banding shall not b	od shall be determined by exact style of support chosen. ruction method shall be determined by exact style of bench end chosen. Veneer edge e used in the construction of bench ends. constructed of solid premium Sauder standard wood specie, and shall include felt		
mmended or 4151. 64" U-notch trowel. When	padding on botton prevent exposed so	n for silencing. Attachment to bench back shall use concealed keyhole design to rew heads.		
stall StrataWorx products, this nd strength and reduce the stalling the carpet tile. anent bond.	Sauder standard fir manually operated allowed to fully air operated spray sys applied using a ma	, and top coat to be a formaldehyde free formulation. Stain color shall be selected from ish samples, or may be matched to customer's sample. Stain shall be applied using a spray system, and then brushed or hand wiped to ensure thorough penetration, an dry. A two-component catalyzed sealer shall then be applied using a manually sem and oven cured. Final top coat shall be a two-component, high solid varnish nually operated spray system, and oven cured. The top coat shall be UV stable to and shall be specially formulated to provide excellent scratch resistance and protection emicals.		PROVAL STAMP PECIFICATIONS
99% 11 95% 11	G. Wood Species: Sau Walnut, Rift Sawn F	der standard wood species are (Red Oak, White Oak, Cherry, Maple, Mahogany, ed Oak, Rift Sawn White Oak).	RUCTI	
97% 11 N/A N/A		shall be responsible for all delivery, unloading, assembly, and complete installation of	SHEET TITLE	
85%     12       99%     12       85%     9	Benches, using facto according to the app expansion anchors d	ry trained regional installation crews. Installation crews shall position the Benches roved floor plan and shall scribe each individual support to fit the floor. Concealed rilled into concrete floors shall be used to secure the Benches. All joints shall be wedged re inserted. Moldings shall be attached with concealed pins to cover exposed screw	T FOR CC	
	<i>3.2 WARRANTY</i> The manufacturer sha defects in materials a	all provide a written twenty-five (25) year warranty (10 years on upholstery) against nd workmanship.	SHEET NO.	G0.10







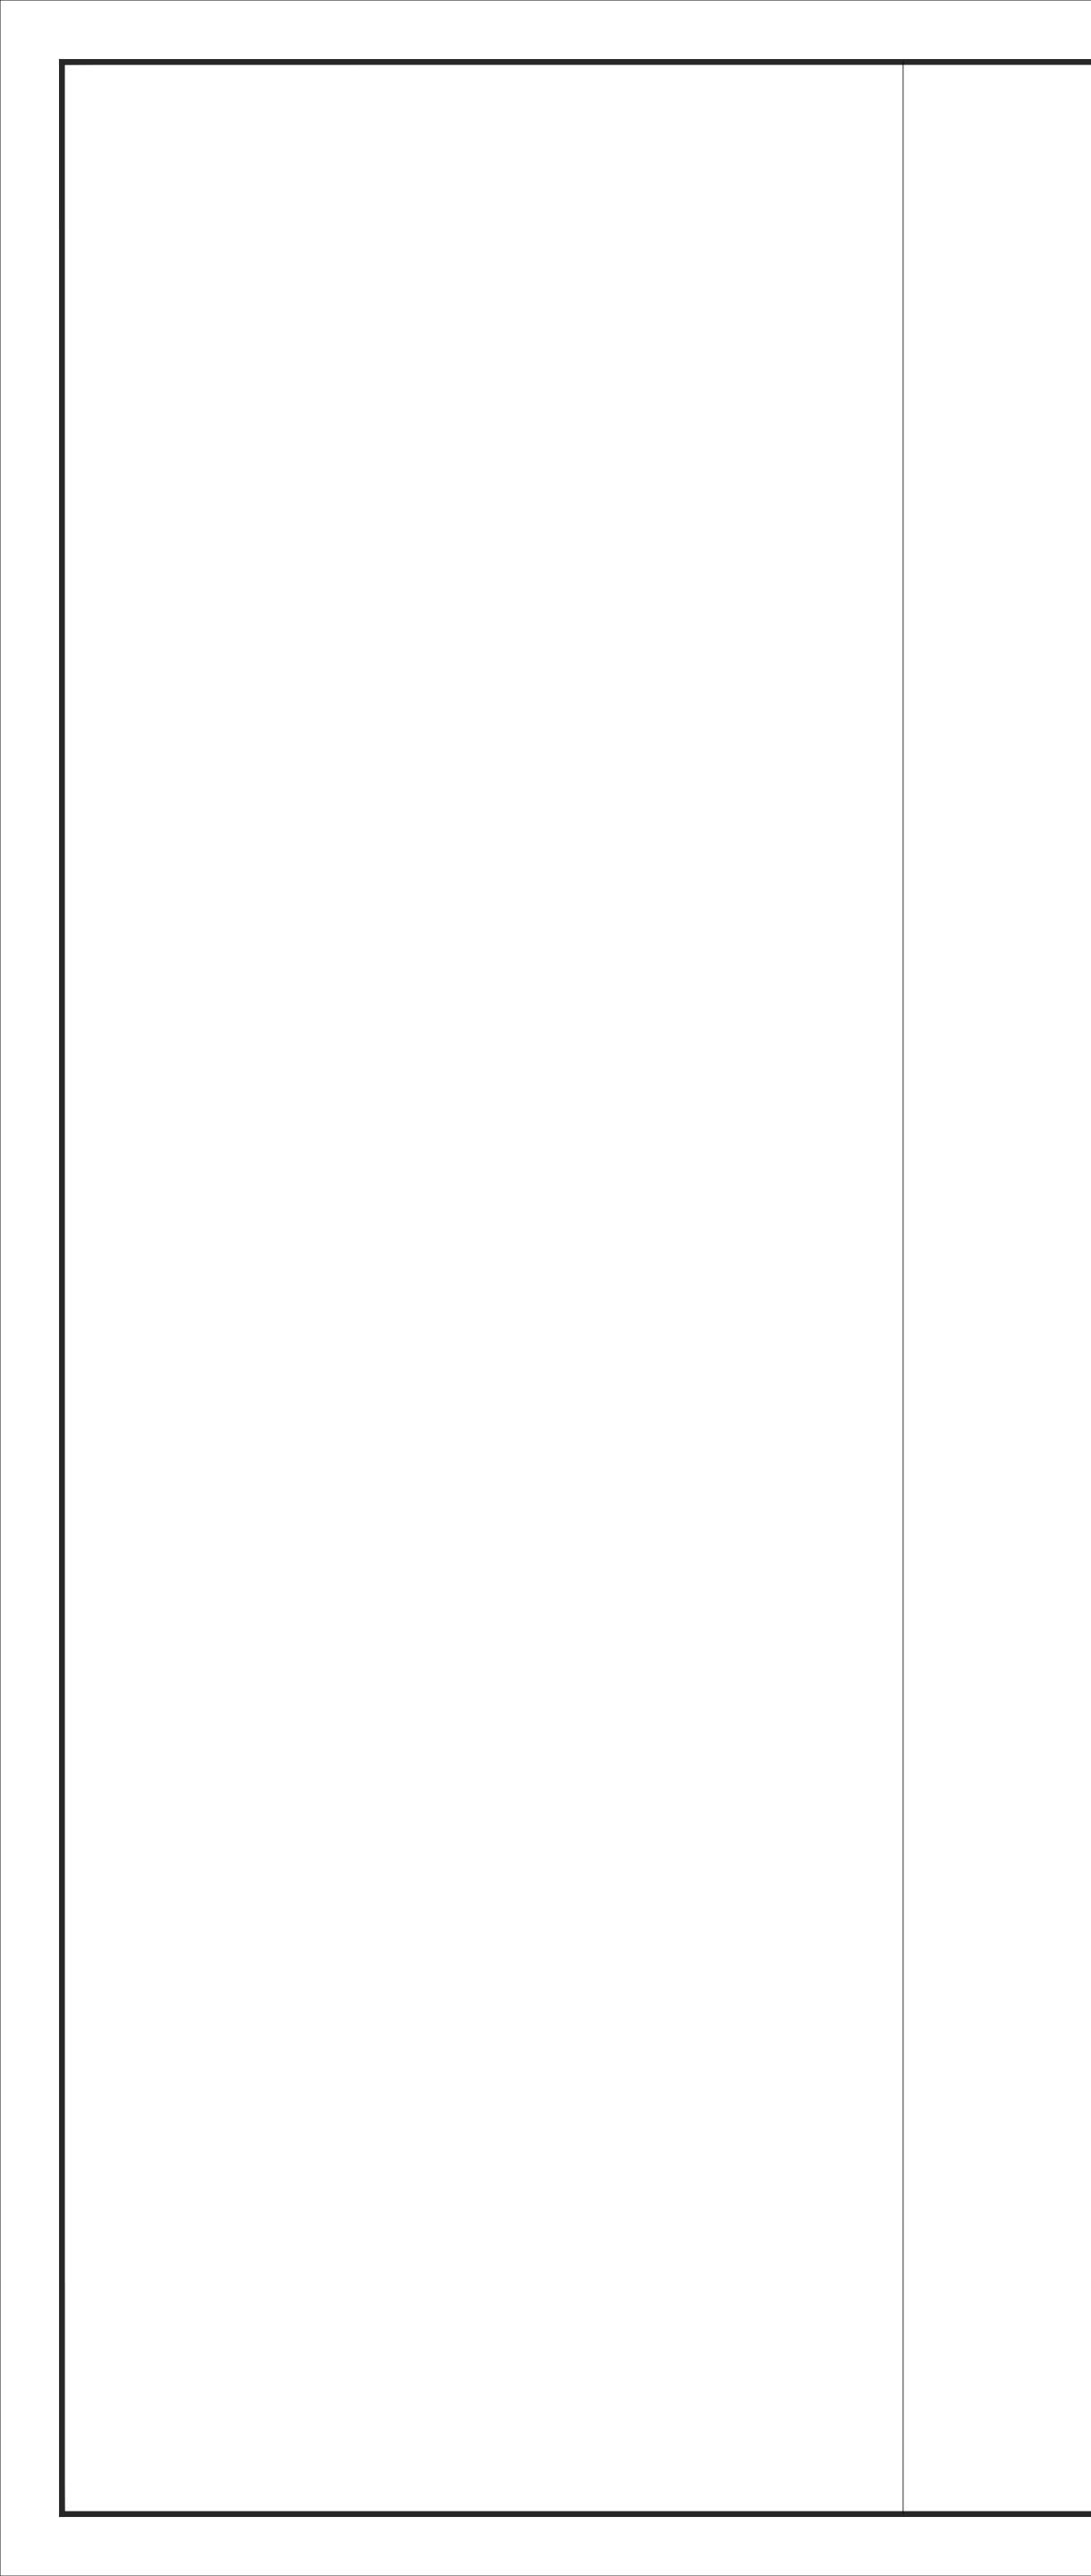

### FINISH LEGEND

C1>	CARPET #2 MANUFAC COLLECTIC STYLE # COLOR SIZE INSTALL N	CTURER ON	OPTION 1 SHAWCONT BISECT TILE 5T448 CLAY 06100 24"X24" SQU ASHLAR		1	*	(N) TR FLOOI FLOOI
(B1)	BASE #1: R MFR: COLOR: SIZE: NOTE:	JOHNS 32 PEB 4"	ONITE	ARPET			
P1	PAINT #1 MFR: COLOR: FINISH: NOTE:		H (E) GLOSS DE SAMPLE F V & APPROV	OR OWNER/AI AL PRIOR TO O			
LE	EGEND	)					
		EXISTIN	<u>G:</u> EXIST	ING WALL T	O REMAIN		
	(	DEMOLIT	ION SCOPE C	DF WORK.			
		EXISTING	FLOORING T	o be remove	D. PREP FLC	OR TO RECEIV	E NEW FL



AREA NOT IN SCOPE OF WORK.

		ABBI	REVIATION
	(N) TRANSITION BETWEEN DIFFERENT FLOOR FINISHES. SEE DETAIL 2/A9.70	A.B. A.C. A/C A.F.F. A.T.	
-	FLOORING PATTERN DIRECTION	ADJ. A.F.S. ALUM. <i>L</i> ANOD. APPROX. ARCH. ASPH. @	AUTOMATIC FIRE SPRINKLEF ALUMINUM ANGLE ANODIZED APPROXIMATELY ARCHITECTURAL
		BD. BLDG. BLKG.	BOARD BUILDING BLOCKING

-LOORING.

ABBF	ANCHOR BOLT		F O C			REINF.	REINFORCED REQUIRED
4.В. 4.С. 4/С	ASPHALT CONCRETE AIR CONDITIONING		F.O.S. F.S.	FACE OF STUD FLOOR SINK		REQ. RESIL.	RESILIENT
А.F.F. А.Т.	ABOVE FINISH FLOOI ACOUSTIC TILE	R	HDR. HDWD.	HEADER HARDWOO HARDWOOD	DD	R.H./RB.H RM.	ROUND HEAD OR ROBE HO ROOM
ADJ. A.F.S.	ADJUSTABLE AUTOMATIC FIRE SPI	RINKLER	HDWR. H.M.	HARDWARE HOLLOW METAL		(R)	RELOCATE
ALUM. <u>/</u>	ALUMINUM ANGLE		HORIZ. H.P.	HORIZONTAL HIGH POINT		SHT. SHTHG.	SHEET SHEATHING
ANOD. APPROX.	ANODIZED APPROXIMATELY		HR. H.R.C. H S B	HOUR HOSE REEL CABINE		SHLV. SIM.	SHELF / SHELVES SIMILAR
ARCH. ASPH. @	ARCHITECTURAL ASPHALT AT		H.S.B. HSS HT.	HIGH STRENGTH BO HOLLOW STEEL SEO HEIGHT		SNK./SKH S.H.	SHEET METAL
ω 3D.	A I BOARD		HT. H.T.D. HTG.	HEIGHT HANDICAP TOWEL HEATING	DISPENSER	S.H.D. S.H.S. S.N.D.	SEE MECHANICAL DRAWIN SHEET METAL SCREW SANITARY NAPKIN DISPOS
BLDG. BLKG.	BUILDING BLOCKING		H.W. H.W.D.	HOT WATER HOT WATER DISPEI	NSER	S.N.D. S.N.V. S.O.V.	SANITARY NAPKIN DISPOS SANITARY NAPKIN VENDO SHUT OFF VALVE
3M. 3.O.J.	BEAM BOTTOM OF JOISTS		I.D.	INSIDE DIAMETER		S.P.D. SK.	SEE PLUMBING DRAWING SPECIFICATIONS
30T. 3.U.	BOTTOM BUILT-UP		INV. INSUL.	INVERT INSULATION		SK. SQ. S.S.	SQUARE SERVICE SINK
CAB.	CABINET		INT.			S.S.D. S.ST.	SEE STRUCTURAL DRAWIN STAINLESS STEEL
CAD. PL. C.A.	CADMIUM PLATED CATCH BASIN		JAN. J.B.	JANITOR JUNCTION BOX.		STD. STL.	STANDARD STEEL
C.B. C.D.	CHALKBOARD CUP DISPENSER		JT. KIT	JOINT KITCHEN		STN. STOR.	STAIN STORAGE
CEM. CER. C.G.	CEMENT CERAMIC CORNER GUARD		KIT. K.O. K.P.	KITCHEN KNOCK-OUT KICK PLATE		STRUCT. SUSP.	STRUCTURAL SUSPENDED
C.I.	CORNER GUARD CHANNEL CAST IRON		K.P. LAM.	LAMINATE		Т&В	TOP AND BOTTOM
C.J. • OR C.L.	CONSTRUCTION JOIN	١T	LAV. LKR.	LAVATORY LOCKER		T.B. TEL. T & G	TOWEL BAR TELEPHONE TONGUE AND GROOVE
CLR. CLG.	CLEAR CEILING		L.P. L.S.D.	LOW POINT LIQUID SOAP DISPE	NSER	T & G T.O T.O.S.	TONGUE AND GROOVE TOP OF TOP OF SLAB
C.M.U. C.O.	CONCRETE MASONR CLEAN OUT	Y UNIT	LT.	LIGHT		T.O.W. T.P.D.	TOP OF WALL TOILET PAPER DISPENSER
COL. COMP.	COLUMN COMPOSITION		MAT. MAX. M.B.	MATERIAL MAXIMUM MACHINE BOLT		TRD. TYP.	TREAD TYPICAL
CONC. CONN. CONT	CONCRETE CONNECTION CONTINUOUS		M.B. MECH. MEMB.	MACHINE BOLI MECHANICAL MEMBRANE		U.L.	
CONT. CONTR. C.T.G.	CONTINUOUS CONTRACTOR CLEAN OUT TO GRAE		MEMB. MFR. M.H.	MEMBRANE MANUFACTURER MANHOLE		UNF. U.O.N.	UNFINISHED UNLESS OTHERWISE NOTE
CTSK. C.W.	CLEAN OUT TO GRAL COUNTERSUNK COLD WATER	JE	N.I.C.	NOT IN CONTRACT		UR. V C P	URINAL
DET.	DETAIL		NO. N.S.F.	NUMBER NET SQUARE FEET		V.C.P. V.C.T. VERT.	VITREOUS CLAY PIPE VINYL COMPOSITION TILE VERTICAL
DO.F. D.F.	DOUGLAS FIR DRINKING FOUNTAIN	J	N.T.S. (N)	NOT TO SCALE NEW		VERT. VEST. V.G.D.F.	VERTICAL VESTIBULE VERTICAL GRAIN DOUGLA
DIA. OR Ø DN.	DIAMETER DIM. DIM DOWN		0.C. 0.D.	ON CENTER OUTSIDE DIAMETE	n	v.G.D.F. V.W.C.	VINYL WALL COVERING
DR. D.S.	door Downspout		O.D. O.DR. OFF.	OUTSIDE DIAMETE OVERFLOW DRAIN OFFICE		W/ W.C.	WITH WATER CLOSET
DWGS.	DRAWINGS DEMOLTION		OFF. O.D. OPNG.	OFFICE OVERHEAD OPENING		W.C. WD. W.H.	WOOD WATER HEATER
EA.	EACH		OPNG. OPP.	OPPOSITE		WNSCT. W.P.	WAINSCOT WATERPROOF or WORK P
E.J. ELECT.	EXPANSION JOINT ELECTRICAL		P.B. P.D.F.	PANIC BAR POWDER DRIVEN F	ASTENER	W.R.	WASTE RECEPTACLE or WATER RESISTANT
ELEV. ENAM. ENCL	ELEVATION ENAMEL ENCLOSURE		P.H. •CORPL.	PHILLIPS HEAD PROPERTY LINE		W.S. W.W.F.	WEATHER STRIPPING WELDED WIRE FABRIC
ENCL. E.P.B. EQ.	ENCLOSURE ELECTRIC PANEL BOA EQUAL	ARD	PLAS. P.LAM.	PLASTER PLASTIC LAMINATE		W.W.M.	WOVEN WIRE MESH
EQ. EQUIP. E.W.A.	EQUAL EQUIPMENT ELECTRIC WATER CO		PLYWD. PNL. POI	PLYWOOD PANEL			
E.W.A. E.W.A. EXH.	ELECTRIC WATER CO ELECTRIC WATER HE EXHAUST		POL. PORC. PR.	POLISHED PORCELAIN PAIR			
EXIST. or (E EXT.	E) EXISTING EXTERIOR		PR. P.S.D. PT.	PAIR POWDER SOAP DIS POINT	PENSER		
=.А. =.В.	FIRE ALARM FLAT BAR		PT. P.T.D. PTN.	POINT PAPER TOWEL DISP PARTITION	PENSER		
BRGL.	FIBERGLASS		P.V.C.	POLYVINYL CHLORI	DE		
D.	FLOOR DRAIN		Q.T.	QUARRY TILE			
=.D. =DN. =.A.	FOUNDATION FIRE EXTINGUISHER	· - · · · ·					
=.D. =DN. =.A. =.A.C. =.A.	FOUNDATION FIRE EXTINGUISHER FIRE EXTINGUISHER ( FIRE HYDRANT OR FL		R. R.A.	RISERS RETURN AIR			
D. -DN. A. A.C. A. A.C. A.C. N.	FOUNDATION FIRE EXTINGUISHER FIRE EXTINGUISHER ( FIRE HYDRANT OR FL FIRE HOSE CABINET FINISH FLOOR	AT HEAD	R. R.A. RAD. R.C.P.	RISERS RETURN AIR RADIUS REINFORCED CONC	CRETE PIPE		
D. -DN. A. A.C. A. A.C. A.C.	FOUNDATION FIRE EXTINGUISHER FIRE EXTINGUISHER ( FIRE HYDRANT OR FL FIRE HOSE CABINET	AT HEAD	R. R.A. RAD.	RISERS RETURN AIR RADIUS	CRETE PIPE		
D. -DN. A. A. A. A. A. O. O. O	FOUNDATION FIRE EXTINGUISHER FIRE EXTINGUISHER FIRE HYDRANT OR FL FIRE HOSE CABINET FINISH FLOOR FINISHED OPENING C FACE OF CONCRETE FACE OF FINISH	AT HEAD DR FACE OF	R. R.A. RAD. R.C.P. RD. R.D. REC.	RISERS RETURN AIR RADIUS REINFORCED CONC ROUND ROOF DRAIN RECESSED	CRETE PIPE		
D. -DN. A. A. A. A. A. O. O. O	FOUNDATION FIRE EXTINGUISHER FIRE EXTINGUISHER OF FIRE HYDRANT OR FL FIRE HOSE CABINET FINISH FLOOR FINISHED OPENING OF FACE OF CONCRETE FACE OF FINISH FACE OF MASONRY	AT HEAD DR FACE OF	R. R.A. RAD. R.C.P. RD. R.D. REC. REF.	RISERS RETURN AIR RADIUS REINFORCED CONC ROUND ROOF DRAIN RECESSED REFERENCE	CRETE PIPE	E	
D. -DN. A. A. A. A. A. O. O. O	FOUNDATION FIRE EXTINGUISHER FIRE EXTINGUISHER FIRE HYDRANT OR FL FIRE HOSE CABINET FINISH FLOOR FINISHED OPENING O FACE OF CONCRETE FACE OF FINISH FACE OF MASONRY	AT HEAD DR FACE OF <b>ND</b> — COLUMN	R. R.A. RAD. R.C.P. RD. REC. REF. OR GRIDLINE	RISERS RETURN AIR RADIUS REINFORCED CONC ROUND ROOF DRAIN RECESSED REFERENCE	#/A3.1		ELEVATION NUMBER & SHEE
D. -DN. A. A. A. A. A. O. O. O	FOUNDATION FIRE EXTINGUISHER FIRE EXTINGUISHER OF FIRE HYDRANT OR FL FIRE HOSE CABINET FINISH FLOOR FINISHED OPENING OF FACE OF CONCRETE FACE OF FINISH FACE OF MASONRY	AT HEAD DR FACE OF <b>ND</b> — COLUMN	R. R.A. RAD. R.C.P. RD. R.D. REC. REF.	RISERS RETURN AIR RADIUS REINFORCED CONC ROUND ROOF DRAIN RECESSED REFERENCE	#/A3.1	ŀ	
D. -DN. A. A. A. A. A. O. O. O	FOUNDATION FIRE EXTINGUISHER FIRE EXTINGUISHER OF FIRE HYDRANT OR FL FIRE HOSE CABINET FINISH FLOOR FINISHED OPENING OF FACE OF CONCRETE FACE OF FINISH FACE OF MASONRY	AT HEAD DR FACE OF <b>ND</b> — COLUMN — SECTION I	R. R.A. RAD. R.C.P. RD. REC. REF. OR GRIDLINE REFERENCE N	RISERS RETURN AIR RADIUS REINFORCED CONC ROUND ROOF DRAIN RECESSED REFERENCE	#/A3.1 #/A3.1 ( #) CONF ROOM ( CONF ( C C C C C C C C C C C C C	F	KEYNOTE REFERENCE ROOM NAME
D. -DN. A. A. A. A. A. O. O. O	FOUNDATION FIRE EXTINGUISHER FIRE EXTINGUISHER FIRE HYDRANT OR FL FIRE HOSE CABINET FINISH FLOOR FINISHED OPENING O FACE OF CONCRETE FACE OF FINISH FACE OF MASONRY BOLS LEGEN	AT HEAD DR FACE OF <b>ND</b> — COLUMN — SECTION I — SECTION I	R. R.A. RAD. R.C.P. RD. REC. REF. OR GRIDLINE REFERENCE N	RISERS RETURN AIR RADIUS REINFORCED CONC ROUND ROOF DRAIN RECESSED REFERENCE	#/A3.1	F	KEYNOTE REFERENCE
D. -DN. A. A. A. A. A. O. O. O	FOUNDATION FIRE EXTINGUISHER FIRE EXTINGUISHER OF FIRE HYDRANT OR FL FIRE HOSE CABINET FINISH FLOOR FINISHED OPENING OF FACE OF CONCRETE FACE OF FINISH FACE OF MASONRY BOLS LEGEN	AT HEAD DR FACE OF <b>ND</b> — COLUMN — SECTION I — SECTION I	R. R.A. RAD. R.C.P. RD. REC. REF. OR GRIDLINE REFERENCE N	RISERS RETURN AIR RADIUS REINFORCED CONC ROUND ROOF DRAIN RECESSED REFERENCE	#/A3.1 #/A3.1 # CONF + ROOM 100 +	F F F	KEYNOTE REFERENCE ROOM NAME ROOM NUMBER ROOM AREA
D. -DN. A. A. A. A. A. O. O. O	FOUNDATION FIRE EXTINGUISHER FIRE EXTINGUISHER FIRE HYDRANT OR FL FIRE HOSE CABINET FINISH FLOOR FINISHED OPENING O FACE OF CONCRETE FACE OF FINISH FACE OF MASONRY BOLS LEGEN	AT HEAD DR FACE OF <b>ND</b> — COLUMN — SECTION I — SECTION I — EXTERIOR	R. R.A. RAD. R.C.P. RD. REC. REF. OR GRIDLINE REFERENCE N REF. SHEET NO REF. SHEET NO	RISERS RETURN AIR RADIUS REINFORCED CONC ROUND ROOF DRAIN RECESSED REFERENCE	#/A3.1 #/A3.1 CONF ROOM 100 # SF +10'-0''	F F F	KEYNOTE REFERENCE ROOM NAME ROOM NUMBER ROOM AREA CEILING HEIGHT
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### PROJECT ADDRESS HALL OF JUSTICE EAST,4TH F,DEPT 30 190 W. HEDDING STREET SAN JOSE, CA 95110

## TENANT IMPROVEMENT for SUPERIOR COURT OF CALIFORNIA COUNTY OF SANTA CLARA



### STAMP

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REVISIONS	
DATE	DESCRIPTION
02.02.2024	ISSUED 50% CD FOR PRICING
03.01.2024	ISSUED 100% CD FOR PRICING
03.08.2024	100% CD FOR CLIENT'S REVIEW

DATE	01.04.2024
SCALE	AS SHOWN
PROJECT ID	2023.205
DRAWN BY	KN/PT

JURISDICTION APPROVAL STAMP

SYMBOLS, ABBREVIATIONS AND LEGENDS

SHEET TITLE

БО.20 SHEET NO.

### A5.602 CALGreen VERIFICATION GUIDELINES MANDATORY MEASURES CHECKLIST

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Application: This checklist shall be used for nonresidential projects that meet one of the following: new construction, building additions of 1,000 square feet or greater, or building alterations with a permit valuation of \$200,000 or more pursuant to Section 301.3 AND do not trigger a Tier 1 or Tier 2 requirement: Y = Yes (section has been selected and/or included)
N/A = Not Applicable (code section does not apply to the project—mainly used for additions and alterations)
O = Other (provide explanation)
[N] = New construction pursuant to Section 301.3
[A] = Additions and/or Alterations pursuant to Section 301.3

APPENDIX A5-NONRESIDENTIAL VOLUNTARY MEASURES

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CHAPTER 5 DIVISIONS		SECTION TITLE	CODE SECTION	Ŷ	N/A	o	PLAN SHEET, SPEC OR ATTACH REFERENCE	•		90
DIVISION 5.1 Planning and Design	Mandatory	Storm water pollution prevention for projects that disturb less than 1 acre of land.	5.106.1 through 5.106.2		X	E C	EXISTÎNG TO REMAIN			
1 1	Mandatory	Short-term bicycle parking (with exception)	5.106.4.1.1			e gan yer e				
بغ د	Mandatory	Long-term bicycle parking	5.106.4.1.2 through 5.106.4.1.5	i c						
	Mandatory	Electric vehicle (EV) charging [N] w/ exceptions	5.106.5.3	1						
	Mandatory	EV capable spaces [N]	5.106.5.3.1			and the				
	Mandatory	Electric vehicle charging stations (EVCS)	5.106.5.3.2							
	Mandatory	Use of automatic load management systems (ALMS)	5.106.5.3.3				l -			
6 67	Mandatory	Accessible EVCS	5.106.5.3.4	-		200				
	Mandatory	Note for EVCS signs	6			, G				
۔ ج	Mandatory	Table 5.106.5.3.1 w/ footnotes	5.106.3.1, 5.106.3.2 and 5.106.3.3							
	Mandatory	Electric vehicle (EV) charging: medium-duty and heavy-duty $[N]$	5,106.5.4				-		£	
-1	Mandatory	Electric vehicle charging readiness requirements for ware- houses, grocery stores and retail stores with planned off- street loading spaces [N]	5.106.5.4.1						- <sup>6</sup>	100
	Mandatory	Table 5.106.5.4.1	5.106.5.4 and 5.106.5.4.1			A CONCEPT OF A CONCEPT OF	8 8		° –	
	Mandatory	Light pollution reduction [N] (with exceptions, notes and table)	5.106.8 through 5.106.8.2				с. Г. — ХАК. — П	-	0 0 0	
c	Mandatory	Grading and paving (exception for additions and alterations not altering the drainage path)	5.106.10						4	
DIVISION 5.2 Energy Efficiency	Mandatory	Meet the minimum energy efficiency standard	5.201.1		2 2 2				0	
DIVISION 5.3 Water	Mandatory	Separate meters (new buildings or additions > 50,000 sf that consume more than 100 gal/day)	5.303.1.1		, <u>, , , , , , , , , , , , , , , , , , </u>					
Efficiency and Conservation (continued)	Mandatory	Separate meters (for tenants in new buildings or additions that consume more than 1,000 gal/day)	5.303.1.2					$\langle \rangle$	6	9
. Transier and	Mandatory	Water closets shall not exceed 1.28 gallons per flush (gpf)	5.303.3.1					"Un l"	, D	0

APPENDIX A5-28

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2022 CALIFORNIA GREEN BUILDING STANDARDS CODE

CHAPTER 5 DIVISIONS		SECTION TITLE	CODE SECTION	Y	N/A	O	PLAN SHEET, SPEC OR ATTACH REFERENCE
(continued) DIVISION 5.3	Mandatory	Wall-mounted urinals shall not exceed 0.125 gpf	5.303.3.2.1	2 0	Х		- 1
Water	Mandatory	Floor-mounted urinals shall not exceed 0.5 gpf	5.303.3.2.2				
Efficiency and Conservation	Mandatory	Single showerhead shall have maximum flow rate of 1.8 gpm (gallons per minute) at 80 psi	5.303.3.3.1				
	Mandatory	Multiple showerheads serving one shower shall have a combined flow rate of 1.8 gpm at 80 psi	5.303.3.3.2	2			
ц ,	Mandatory	Nonresidential lavatory faucets	5.303.3.4.1				
-	Mandatory	Kitchen faucets	5.303.3.4.2	5			
	Mandatory	Wash fountains	5.303.3.4.3				
,	Mandatory	Metering faucets	5.303.3.4.4				c
	Mandatory	Metering faucets for wash fountains	5.303.3.4.5	2			
	Mandatory	Pre-rinse spray valve	5.303.3.4.6				
0 192	Mandatory	Food waste disposers	5.303.4.1				
C	Mandatory	Areas of additions or alterations	5.303.5				
	Mandatory	Standards for plumbing fixtures and fittings	5.303.6				a.
	Mandatory	Outdoor potable water use in landscape areas (with notes)	5.304.1				
DIVISION 5.4	Mandatory	Weather protection	5.407.1	X			EXISTING TO REMAIN
Material Conservation	Mandatory	Moisture control: sprinklers	5.407.2.1				
and Resource Efficiency	Mandatory	Moisture control: exterior door protection	5.407.2.2.1			0	
(continued)	Mandatory	Moisture control: flashing	5.407.2.2.2				
и в. ()	Mandatory	Construction waste management—comply with either: Sections 5.408.1.1, 5.408.1.2, 5.408.1.3 or more strin- gent local ordinance	5.408.1.1, 5.408.1.2, 5.408.1.3	x	0	(	CONTRACTOR SH COMPLY.
	Mandatory	Construction waste management: documentation	5.408.1.4	Х	-		CONTRACTOR SH COMPLY.
₀⊐	Mandatory	Universal waste [A]	5.408.2		Х	-	
	Mandatory	Excavated soil and land clearing debris (100% reuse or recycle)	5.408.3		x	•	
	Mandatory	Recycling by occupants (with exception)	5.410.1	Х			TENANT SHALL COMPLY
	Mandatory	Recycling by occupants: additions (with exception)	5.410.1.1		X		
	Mandatory	Recycling by occupants: sample ordinance	5.410.1.2		1		U
	Mandatory	Commissioning new buildings (≥ 10,000 sf) [N]	5.410.2			White equalities	Conser del mandalador de la conservation de
	Mandatory	Owner's or owner representative's Project Require- ments (OPR) [N]	5.410.2.1				
	Mandatory	Basis of Design (BOD) [N]	5.410.2.2		T		

APPENDIX A5-NONRESIDENTIAL VOLUNTARY MEASURES

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2022 CALIFORNIA GREEN BUILDING STANDARDS CODE

APPENDIX A5-29 APPENDIX A5-30 


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	20														o	n		
CHAPTER 5 DIVISIONS		SECTION TITLE	CODE SECTION	Y	N/A	o	PLAN SHEET, SPEC OR ATTACH REFERENCE			CHAPTER 5 DIVISIONS		SECTION TITLE	CODE SECTION	Ŷ	N/A. 0	PLAN SHEET, SPEC OR ATTACH REFERENCE		
(continued) DIVISION 5.4	Mandatory	Commissioning plan [N]	5.410.2.3		X		)	- -		(continued)	Mandatory	Filters (with exceptions)	5.504.5.3	2	X			
Material Conservation	Mandatory	Functional performance testing [N]	5.410.2.4				e	1		DIVISION 5.5 Environmental	Mandatory	Filters: labeling	5.504.5.3.1	2		1.1		
and Resource	Mandatory	Documentation and training [N]	5,410,2.5							Quality	Mandatory	Environmental tobacco smoke (ETS) control	5,504,7					
Efficiency	Mandatory	Systems manual [N]	5.410.2.5.1			1					Mandatory	Indoor moisture control	5.505.1	0				
G	Mandatory	Systems operation training [N]	5.410.2.5.2								Mandatory	Outside air delivery	5.506.1	1				
0 <sub>11</sub> 0	Mandatory	Commissioning report [N]	5.410.2.6			-				а. -	Mandatory	Carbon dioxide (CO <sub>2</sub> ) monitoring	5.506.2	5				
	Mandatory	Testing and adjusting for new buildings < 10,000 sf or new systems that serve additions or alterations [A]	5.410.4	2			*		81		Mandatory	Acoustical control (with exception)	5.507.4			и и на		
n e	Mandatory	System testing plan for renewable energy, landscape irrigation and water reuse [A]	5,410,4.2	с. 							Mandatory	Exterior noise transmission, prescriptive method (with exceptions)	5.507.4.1	,				
	Mandatory	Procedures for testing and adjusting	5.410.4.3				12			- -	Mandatory	Noise exposure where noise contours are not readily available	5.507.4.1.1					
	Mandatory	Procedures for HVAC balancing	5.410,4,3,1				UUU ERMP AAU	L L		6 	Mandatory	Performance method	5,507,4.2			- <u>-</u>		
u U	Mandatory	Reporting for testing and adjusting	5.410.4.4						n	a	Mandatory	Site features	5.507.4.2.1	- <u></u> ,				
	Mandatory	Operation and maintenance (O&M) manual	5.410.4.5								Mandatory	Documentation of compliance	5.507.4.2.2		5	- F		
	Mandatory	Inspection and reports	5.410.4.5.1						F (r	Mandatory	Interior sound transmission (with note)	5.507.4.3						
DIVISION 5.5 Invironmental	Mandatory	Fireplaces	5,503,1								Mandatory	Ozone depletion and greenhouse gas reductions	5.508.1					
Quality	Mandatory	Woodstoves	5.503.1.1		T		r				Mandatory	Chlorofluorocarbons (CFCs)	5.508.1.1	Ċ				
(continued)	Mandatory	Temporary ventilation	5.504.1	Х		cc	ONTRACTOR SHAL COMPLY.				Mandatory	· Halons	5.508.1.2					
υ	Mandatory	Covering of ducts openings and protection of mechan- ical equipment during construction	5.504.3	x	2	CC	ONTRACTOR SHAL COMPLY.		r.	-		с, -	Mandatory	Supermarket refrigerant leak reduction for retail food stores 8,000 square feet or more Sections 5.508.2 through 5.508.2.6.3	5.508.2 through 5.508.2.6.3		V	
L.	Mandatory	Adhesives, sealants and caulks	5.504.4.1	X	· · ·		DESIGN COMPLIES.		٩				5,500,2.0,5	ŀ				
	Mandatory	Paints and coatings	5.504.4.3		X		- llo-antono de 1914 de antono en 1913					END OF MANDATORY PROVISIONS		<u> </u>				
8	Mandatory	Aerosol paints and coatings	5.504.4.3.1		X	C			0	0	0 0 0		0					
D	Mandatory	Aerosol paints and coatings: verification	5.504.4.3.2		Х		D			c					R			
	Mandatory	Carpet systems	5.504.4.4	X					2						5			
	Mandatory	Carpet cushion	5.504.4.4.1	Х						Documentation	Author's / R	esponsible Designer's Declaration Statement	<u></u>	7	<u> </u>			
	Mandatory	Carpet adhesives per Table 5.504.4.1	5.504.4.4.2	х	ſ				1		Mandal	ory: I attest	that this mandatory provisions checklist is accurate	and complete.	c	)		
	Mandatory	Composite wood products	5,504.4.5		Х					Signature:			100 2 K2 80 4 284 4 1	në -	110 INT 1853			
	Mandatory	Composite wood products: documentation	5.504.4.5.3		Х						KELLEY	SIMCOX ::	Data	E 2762				
	Mandatory	Resilient flooring systems	5.504.4.6	Х						Company:	STUDIO	G ARCHITECTS INC.	Date: 02/	/2024	۱ 			
	Mandatory	Resilient flooring: verification of compliance	5.504.4.6.1	Х			- 17 - 18 - 19 - 7 - 19 - 8 - 19 - 19 - 19 - 19 - 19 - 19			Address:	299 BAS	SSETT ST. SUITE 250	License:					
	Mandatory	Thermal insulation	5.504.4.7	X		8	UL N. W.			City/State/Zip:	ςανι ι	SE , CA-, 95110	Phone: 408	.283.0	0100			
	Mandatory	Verification of compliance	5.504.4.7.1	Х						L			400	.205.0		]		
	Mandatory	Acoustical ceilings and wall panels	5.504.4.8		х			_en co T		c	<u> </u>							
•	Mandatory	Verification of compliance	5.504.4.8.1	]	Х		с С						• • F					

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2022 CALIFORNIA GREEN BUILDING STANDARDS CODE

2022 CALIFORNIA GREEN BUILDING STANDARDS CODE

APPENDIX A5-31



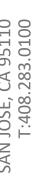

## PROJECT ADDRESS HALL OF JUSTICE EAST,4TH F,DEPT 30 190 W. HEDDING STREET SAN JOSE, CA 95110

## TENANT IMPROVEMENT for SUPERIOR COURT OF CALIFORNIA **COUNTY OF SANTA CLARA**



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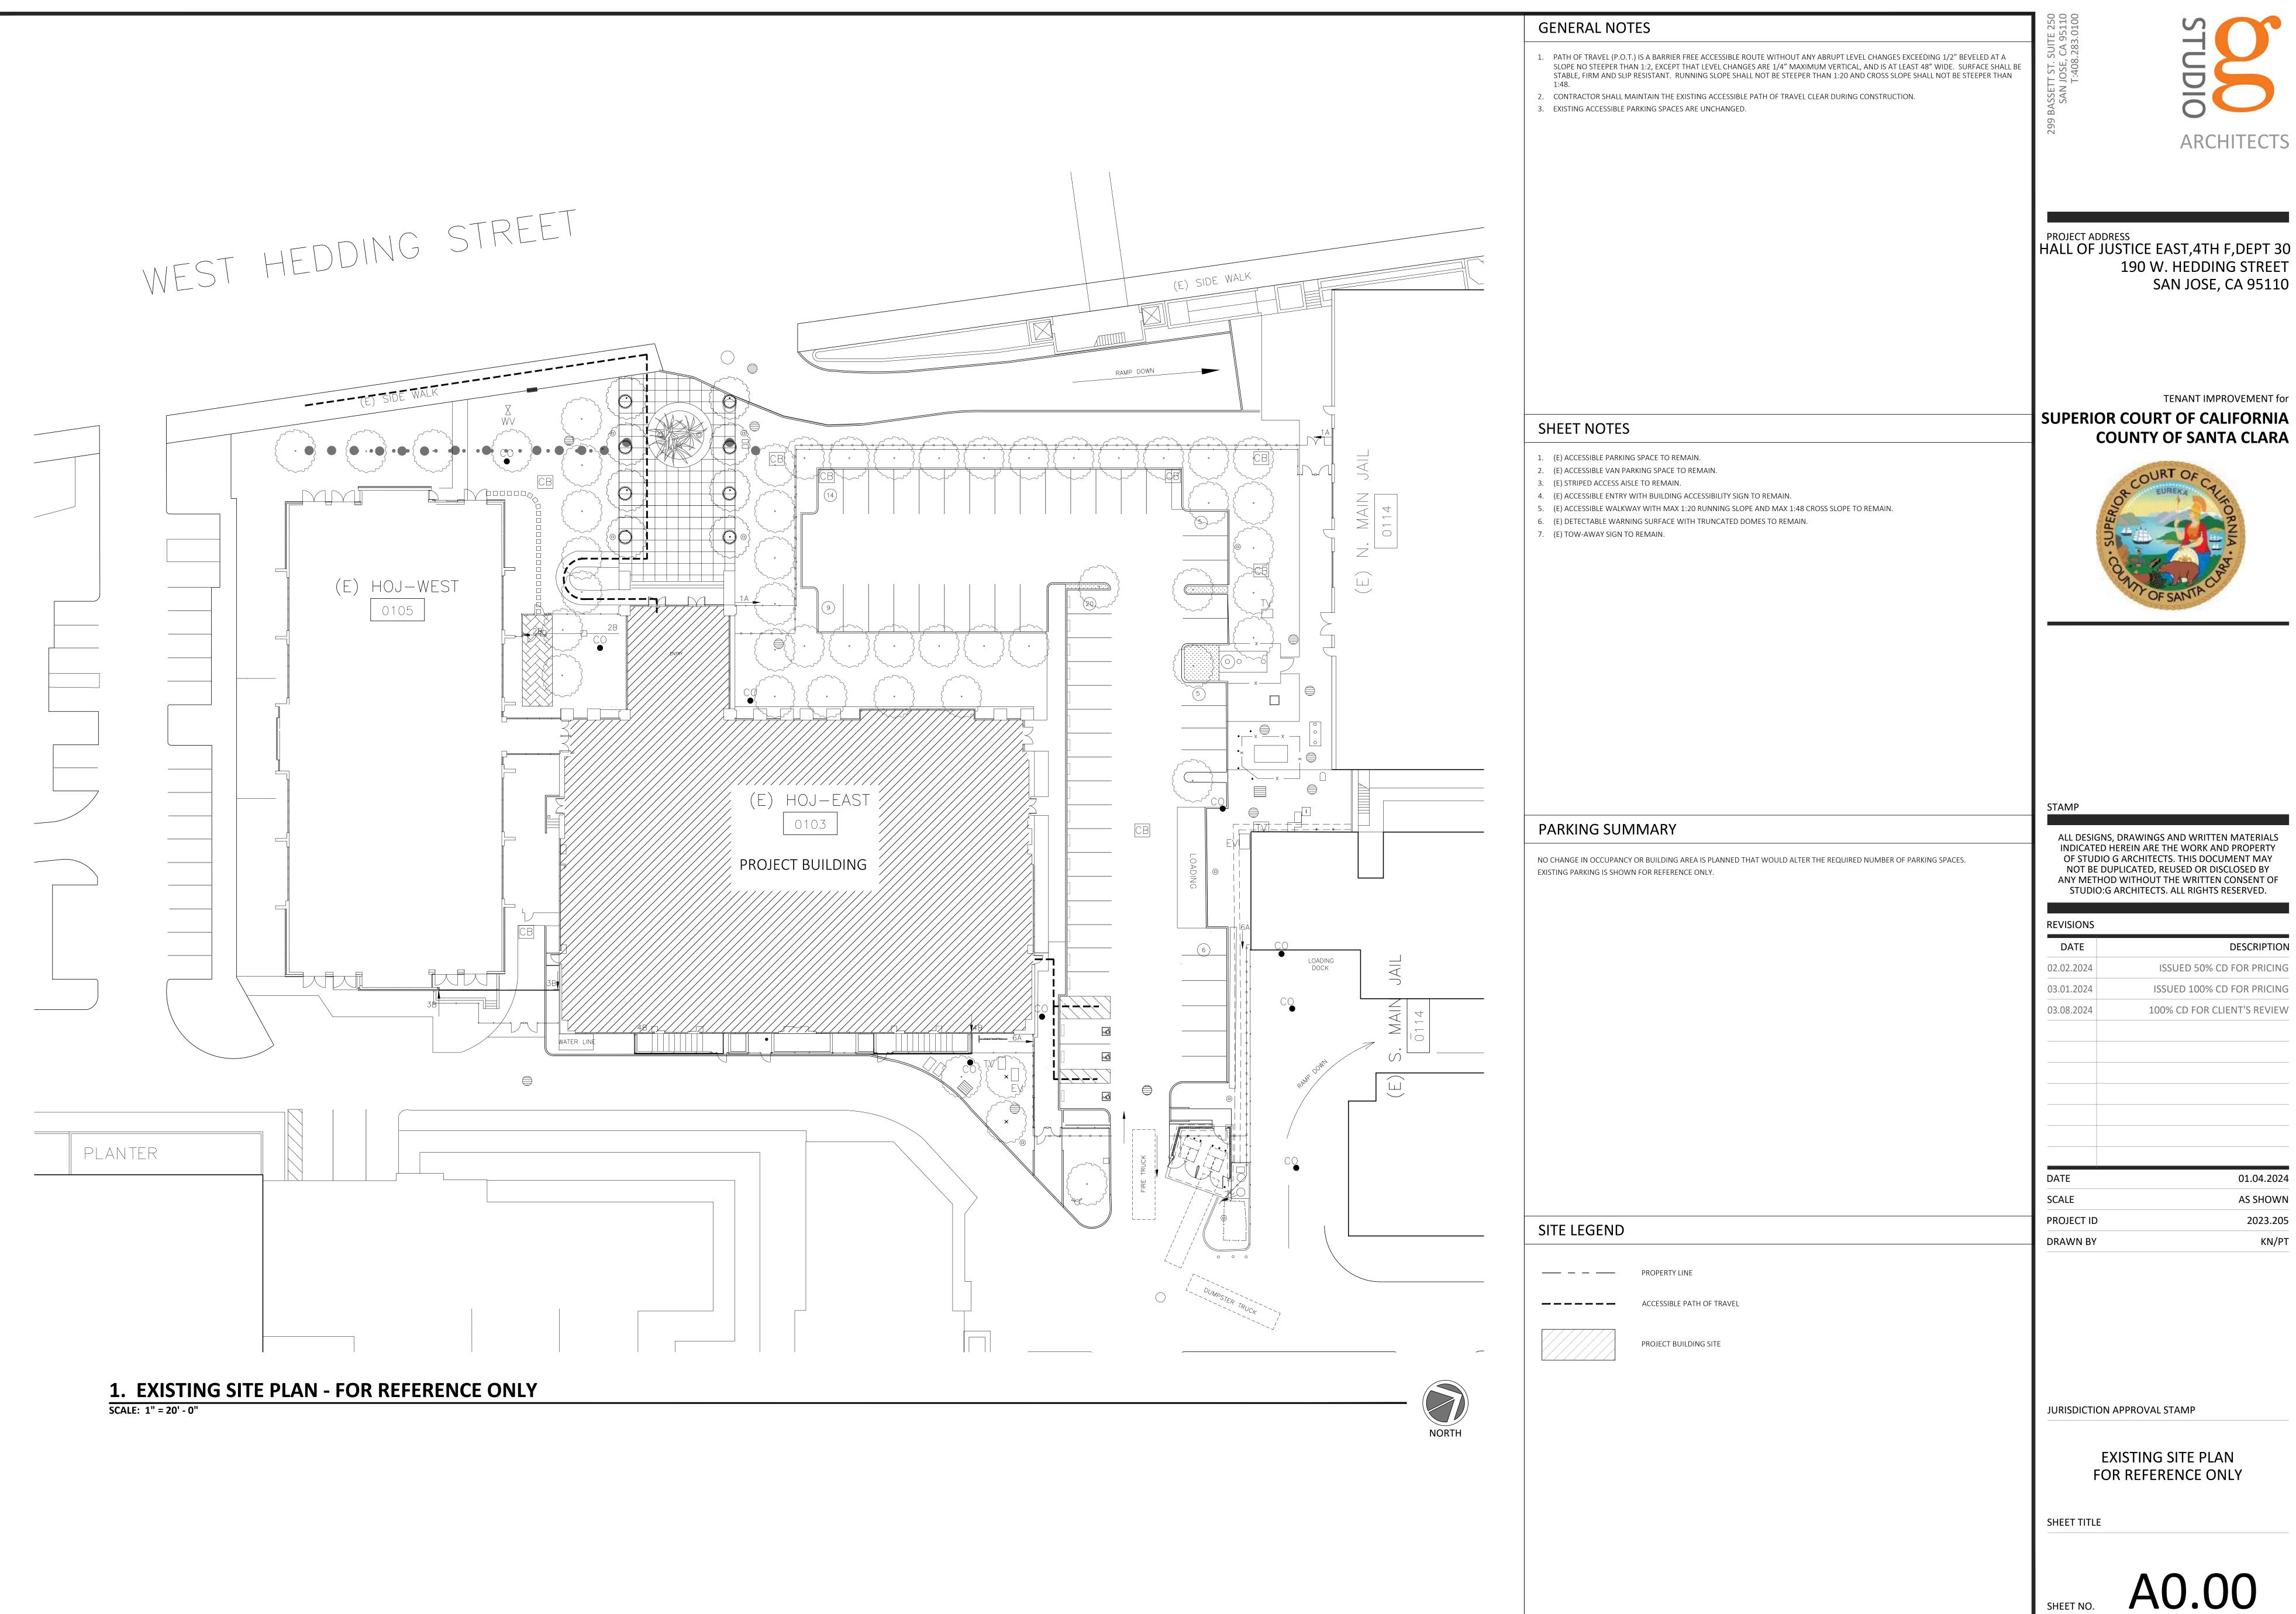
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PROJECT ID	2023.205
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CALGREEN CHECKLIST

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EXISTING SITE PLAN FOR REFERENCE ONLY

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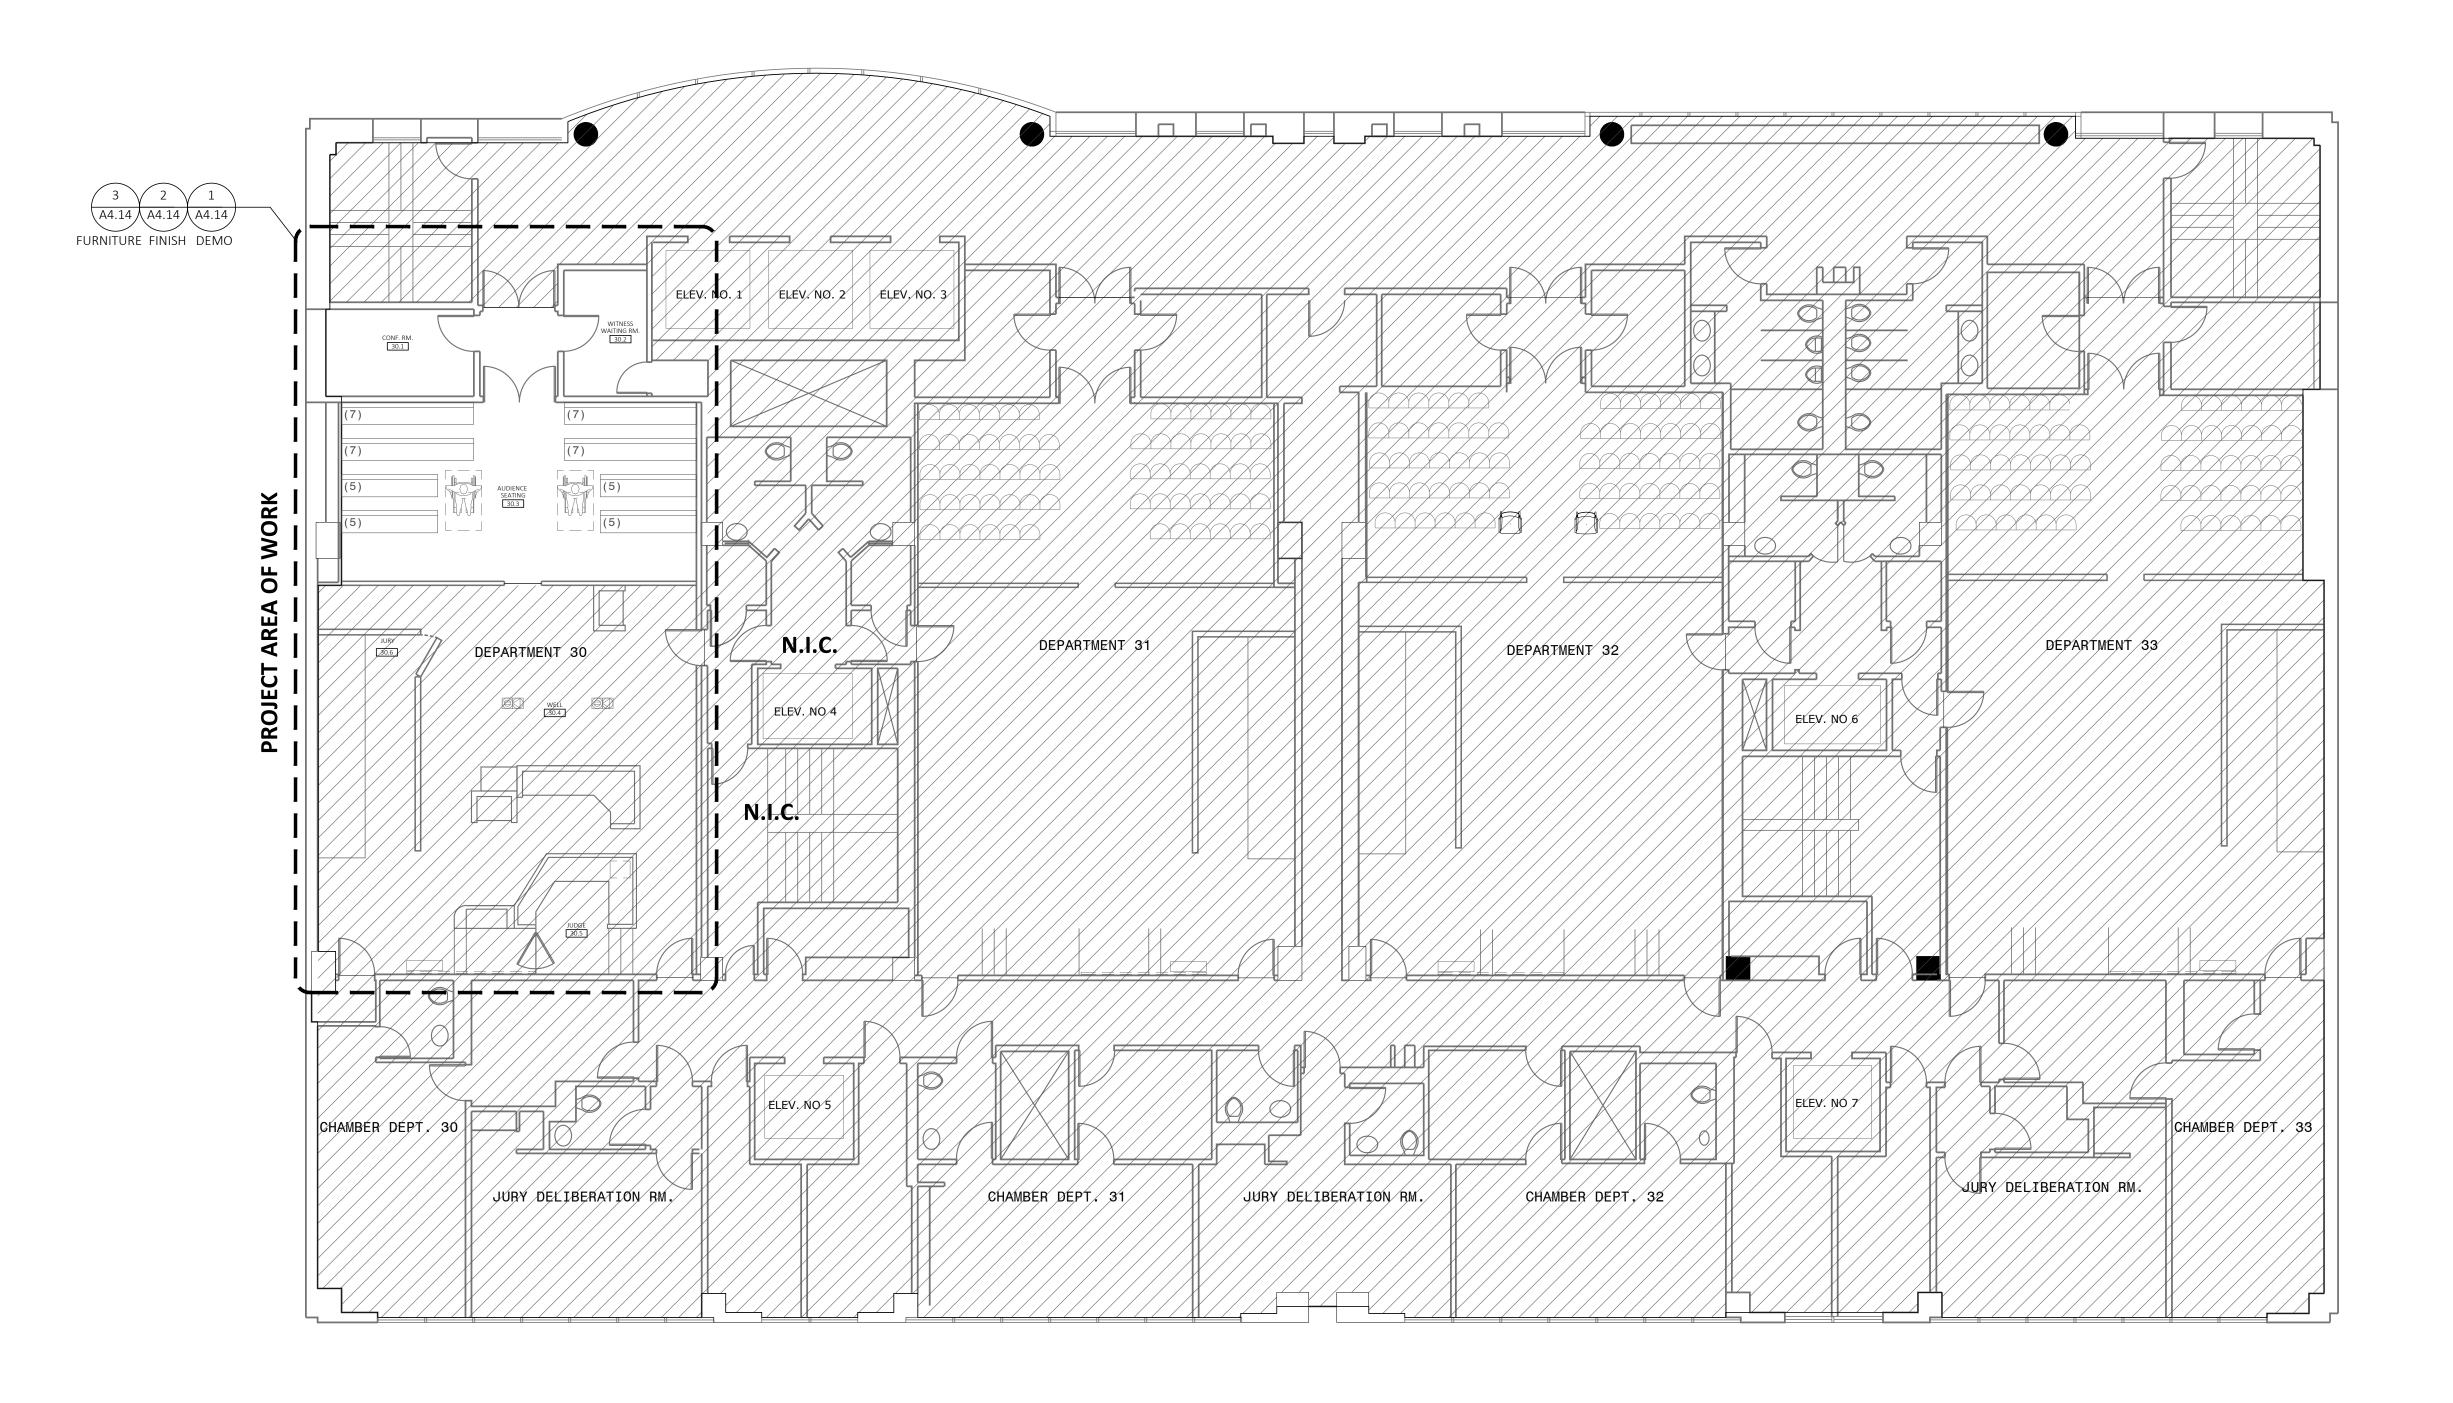
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## TENANT IMPROVEMENT for **SUPERIOR COURT OF CALIFORNIA COUNTY OF SANTA CLARA**

190 W. HEDDING STREET SAN JOSE, CA 95110





## **1. 4TH FLOOR PLAN - OVERALL**

SCALE: 1/8"=1'-0"













# PROJECT ADDRESS HALL OF JUSTICE EAST,4TH F,DEPT 30 190 W. HEDDING STREET SAN JOSE, CA 95110

## TENANT IMPROVEMENT for SUPERIOR COURT OF CALIFORNIA **COUNTY OF SANTA CLARA**



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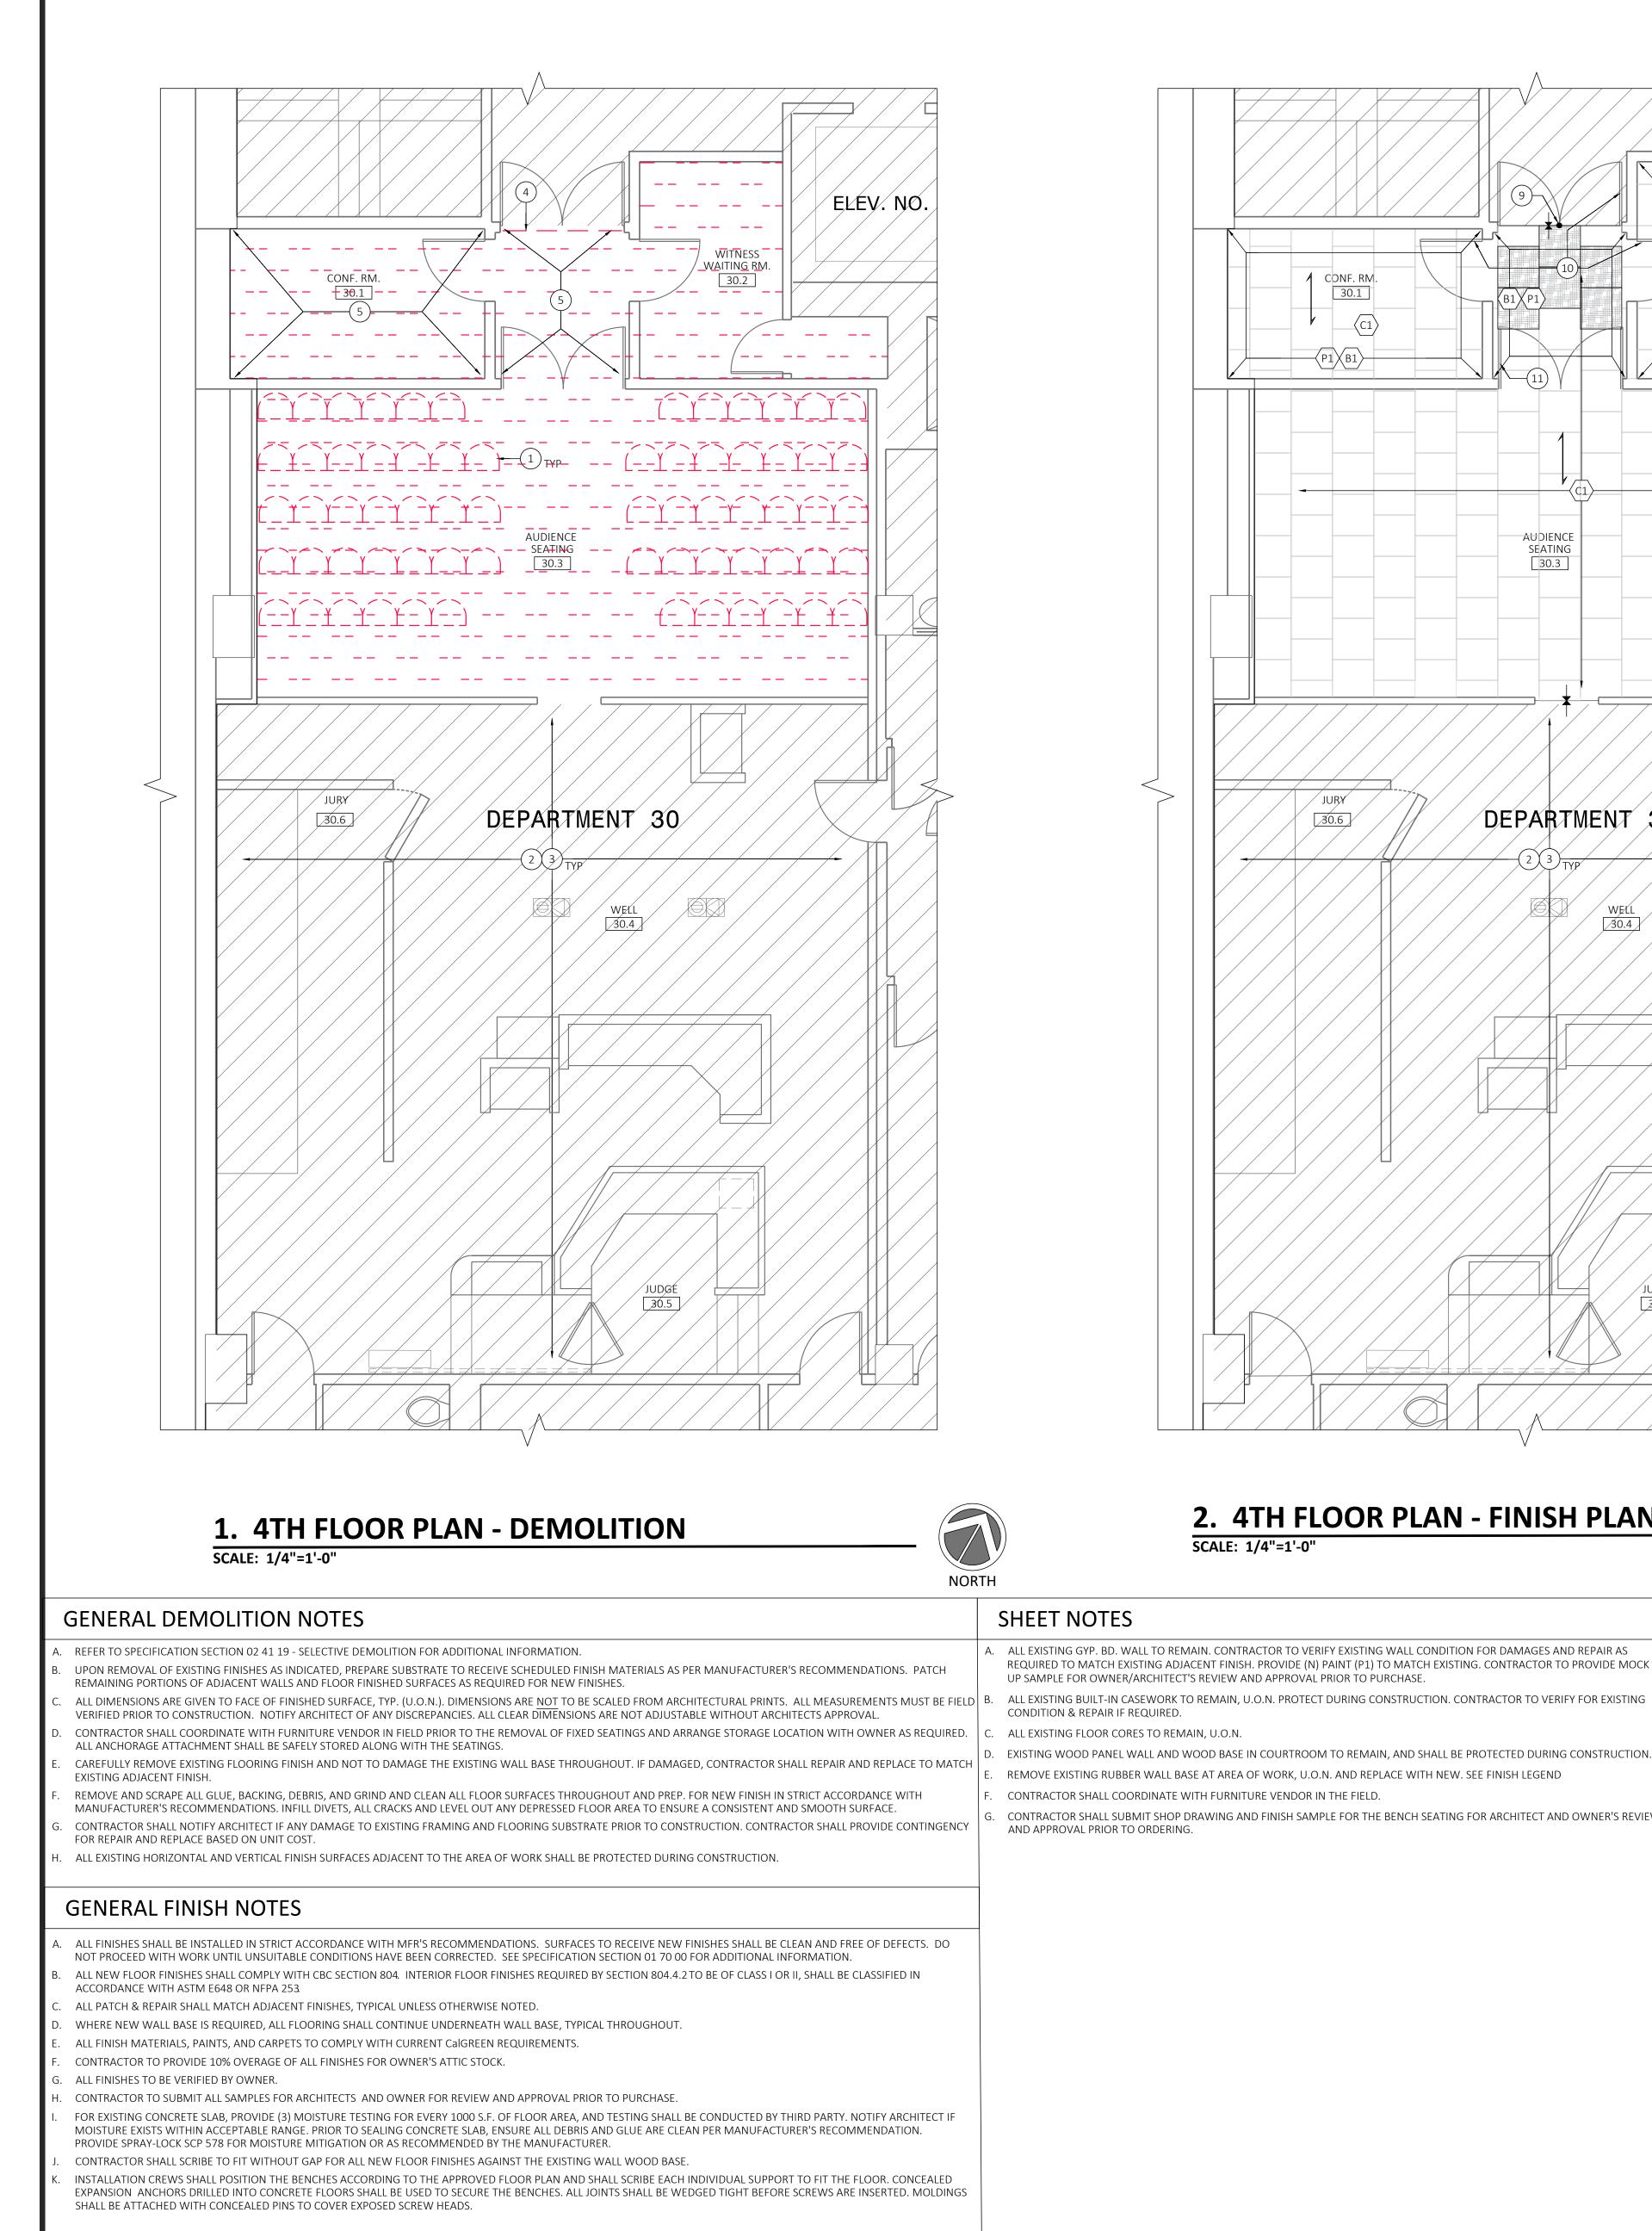
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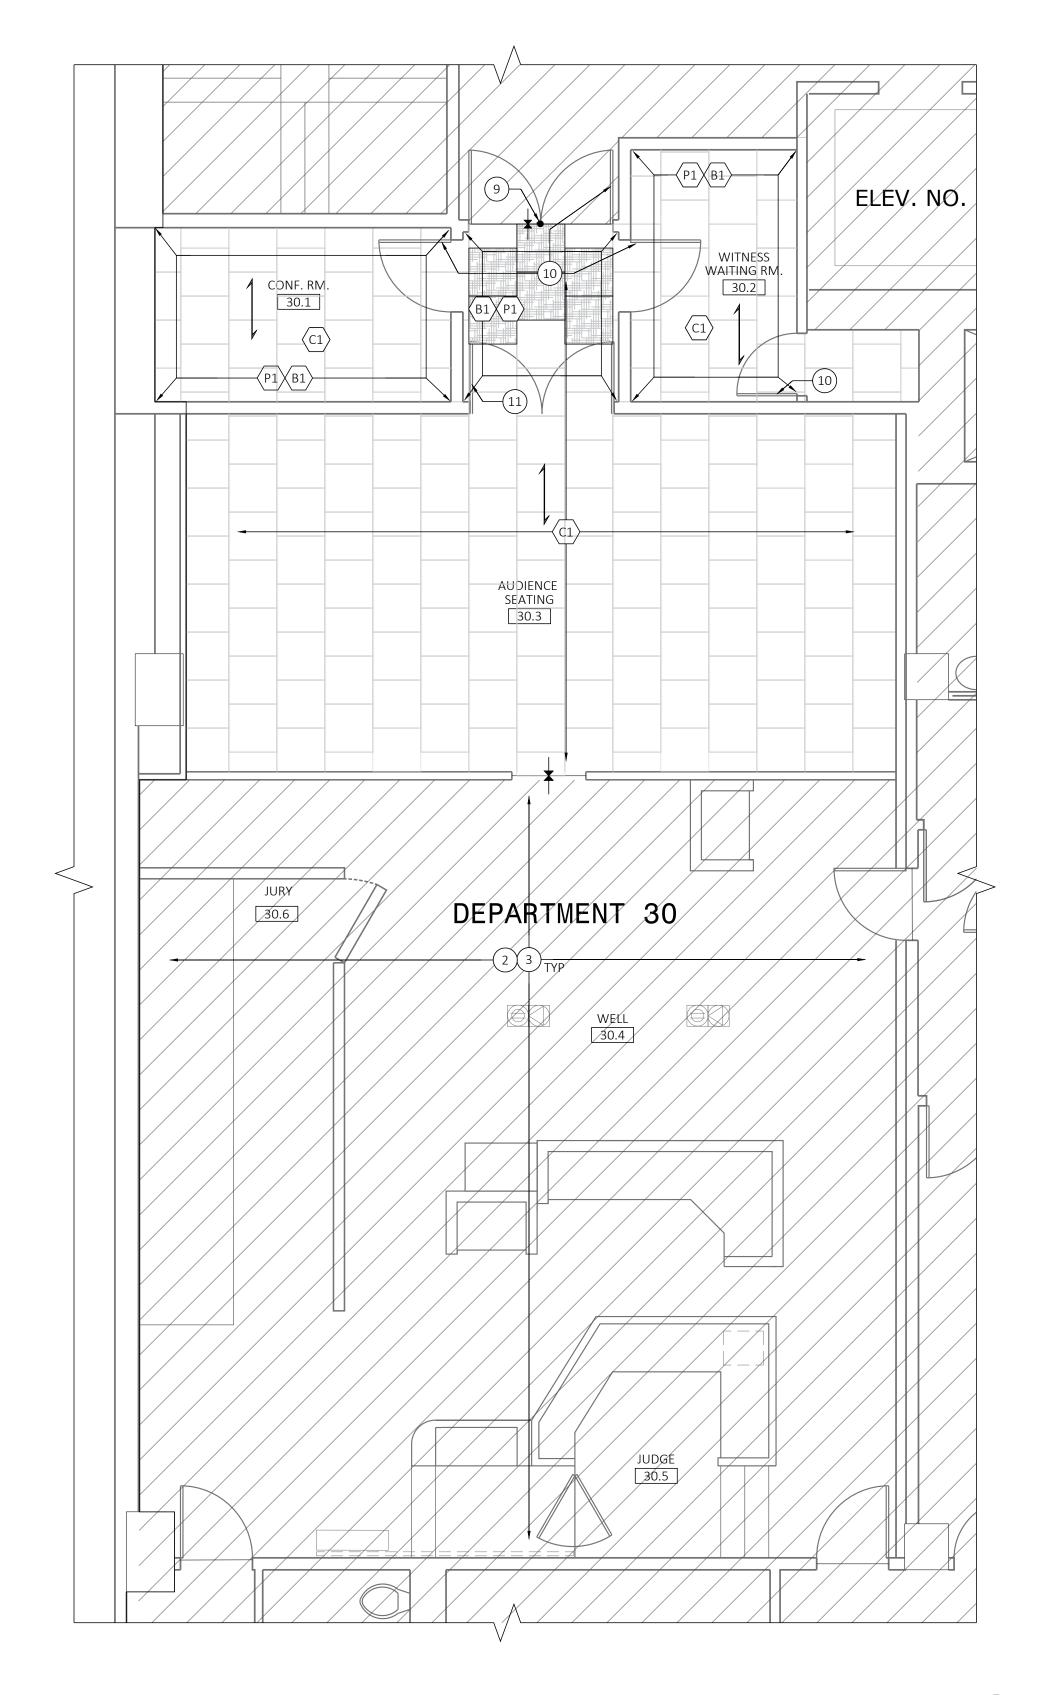
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4TH FLOOR PLAN OVERALL

SHEET TITLE







### 2. 4TH FLOOR PLAN - FINISH PLAN SCALE: 1/4"=1'-0" NORTH

### SHEET NOTES

A. ALL EXISTING GYP. BD. WALL TO REMAIN. CONTRACTOR TO VERIFY EXISTING WALL CONDITION FOR DAMAGES AND REPAIR AS REQUIRED TO MATCH EXISTING ADJACENT FINISH. PROVIDE (N) PAINT (P1) TO MATCH EXISTING. CONTRACTOR TO PROVIDE MOCK UP SAMPLE FOR OWNER/ARCHITECT'S REVIEW AND APPROVAL PRIOR TO PURCHASE.

CONDITION & REPAIR IF REQUIRED.

ALL EXISTING FLOOR CORES TO REMAIN, U.O.N.

EXISTING WOOD PANEL WALL AND WOOD BASE IN COURTROOM TO REMAIN, AND SHALL BE PROTECTED DURING CONSTRUCTION. REMOVE EXISTING RUBBER WALL BASE AT AREA OF WORK, U.O.N. AND REPLACE WITH NEW. SEE FINISH LEGEND

CONTRACTOR SHALL COORDINATE WITH FURNITURE VENDOR IN THE FIELD.


CONTRACTOR SHALL SUBMIT SHOP DRAWING AND FINISH SAMPLE FOR THE BENCH SEATING FOR ARCHITECT AND OWNER'S REVIEW AND APPROVAL PRIOR TO ORDERING.

### KEYNOTES

- REMOVE (E) FLOOR MOUNTED SEATING SHOWN IN RED & ALL ASSOCIATED ATTACHMENTS THROUGHOUT. PATCH & REPAIR FLOOR SUBSTRATE AS REQUIRED.
- (E) CARPET FLOORING TO REMAIN.
- 3. NO WORK IN THIS AREA. ALL EXISTING CONDITIONS TO REMAIN. U.O.N.
- CONTRACTOR TO REMOVE EXISTING FLOORING TRANSITION STRIP. SEE PHOTO ON SHEET A10.SERIES. REMOVE (E) WALL BASE AND PREPARE SURFACE TO RECEIVE NEW WALL BASE.
- BASE BID PROVIDE (N) ALL WOOD BENCH SEATING: SAUDER COURTROOM. PRODUCT NUMBER (301-4016) VENEER CONTOURED
- SEAT, FLAT BACK, WOOD TYPE: CHERRY, 2200 ENDLESS ENDS, FLUSH BASE SHOES ANCHORED. 6.1 ALTERNATE BID- PROVIDE (N) ALL WOOD BENCH SEATING: SAUDER COURTROOM. PRODUCT NUMBER (301-4016) VENEER
- FLUSH BASE SHOES ANCHORED. CONTRACTOR SHALL COORDINATE WITH FURNITURE VENDOR IN FIELD AND CONFIRM LAYOUT WITH ARCHITECT & OWNER PRIOR
- TO INSTALLATION. (E) FURNITURE & BUILT IN CASEWORK TO REMAIN.
- INSTALLATION.
- BEFORE ORDERING NEW PAINT.

## SEAT COUNT SUMMARY

DEPARTMENT #30 - SA	UDER COURT
(E) STANDARD	(E) ADA
66	2
(N) STANDARD	(N) ADA REQ
48	2

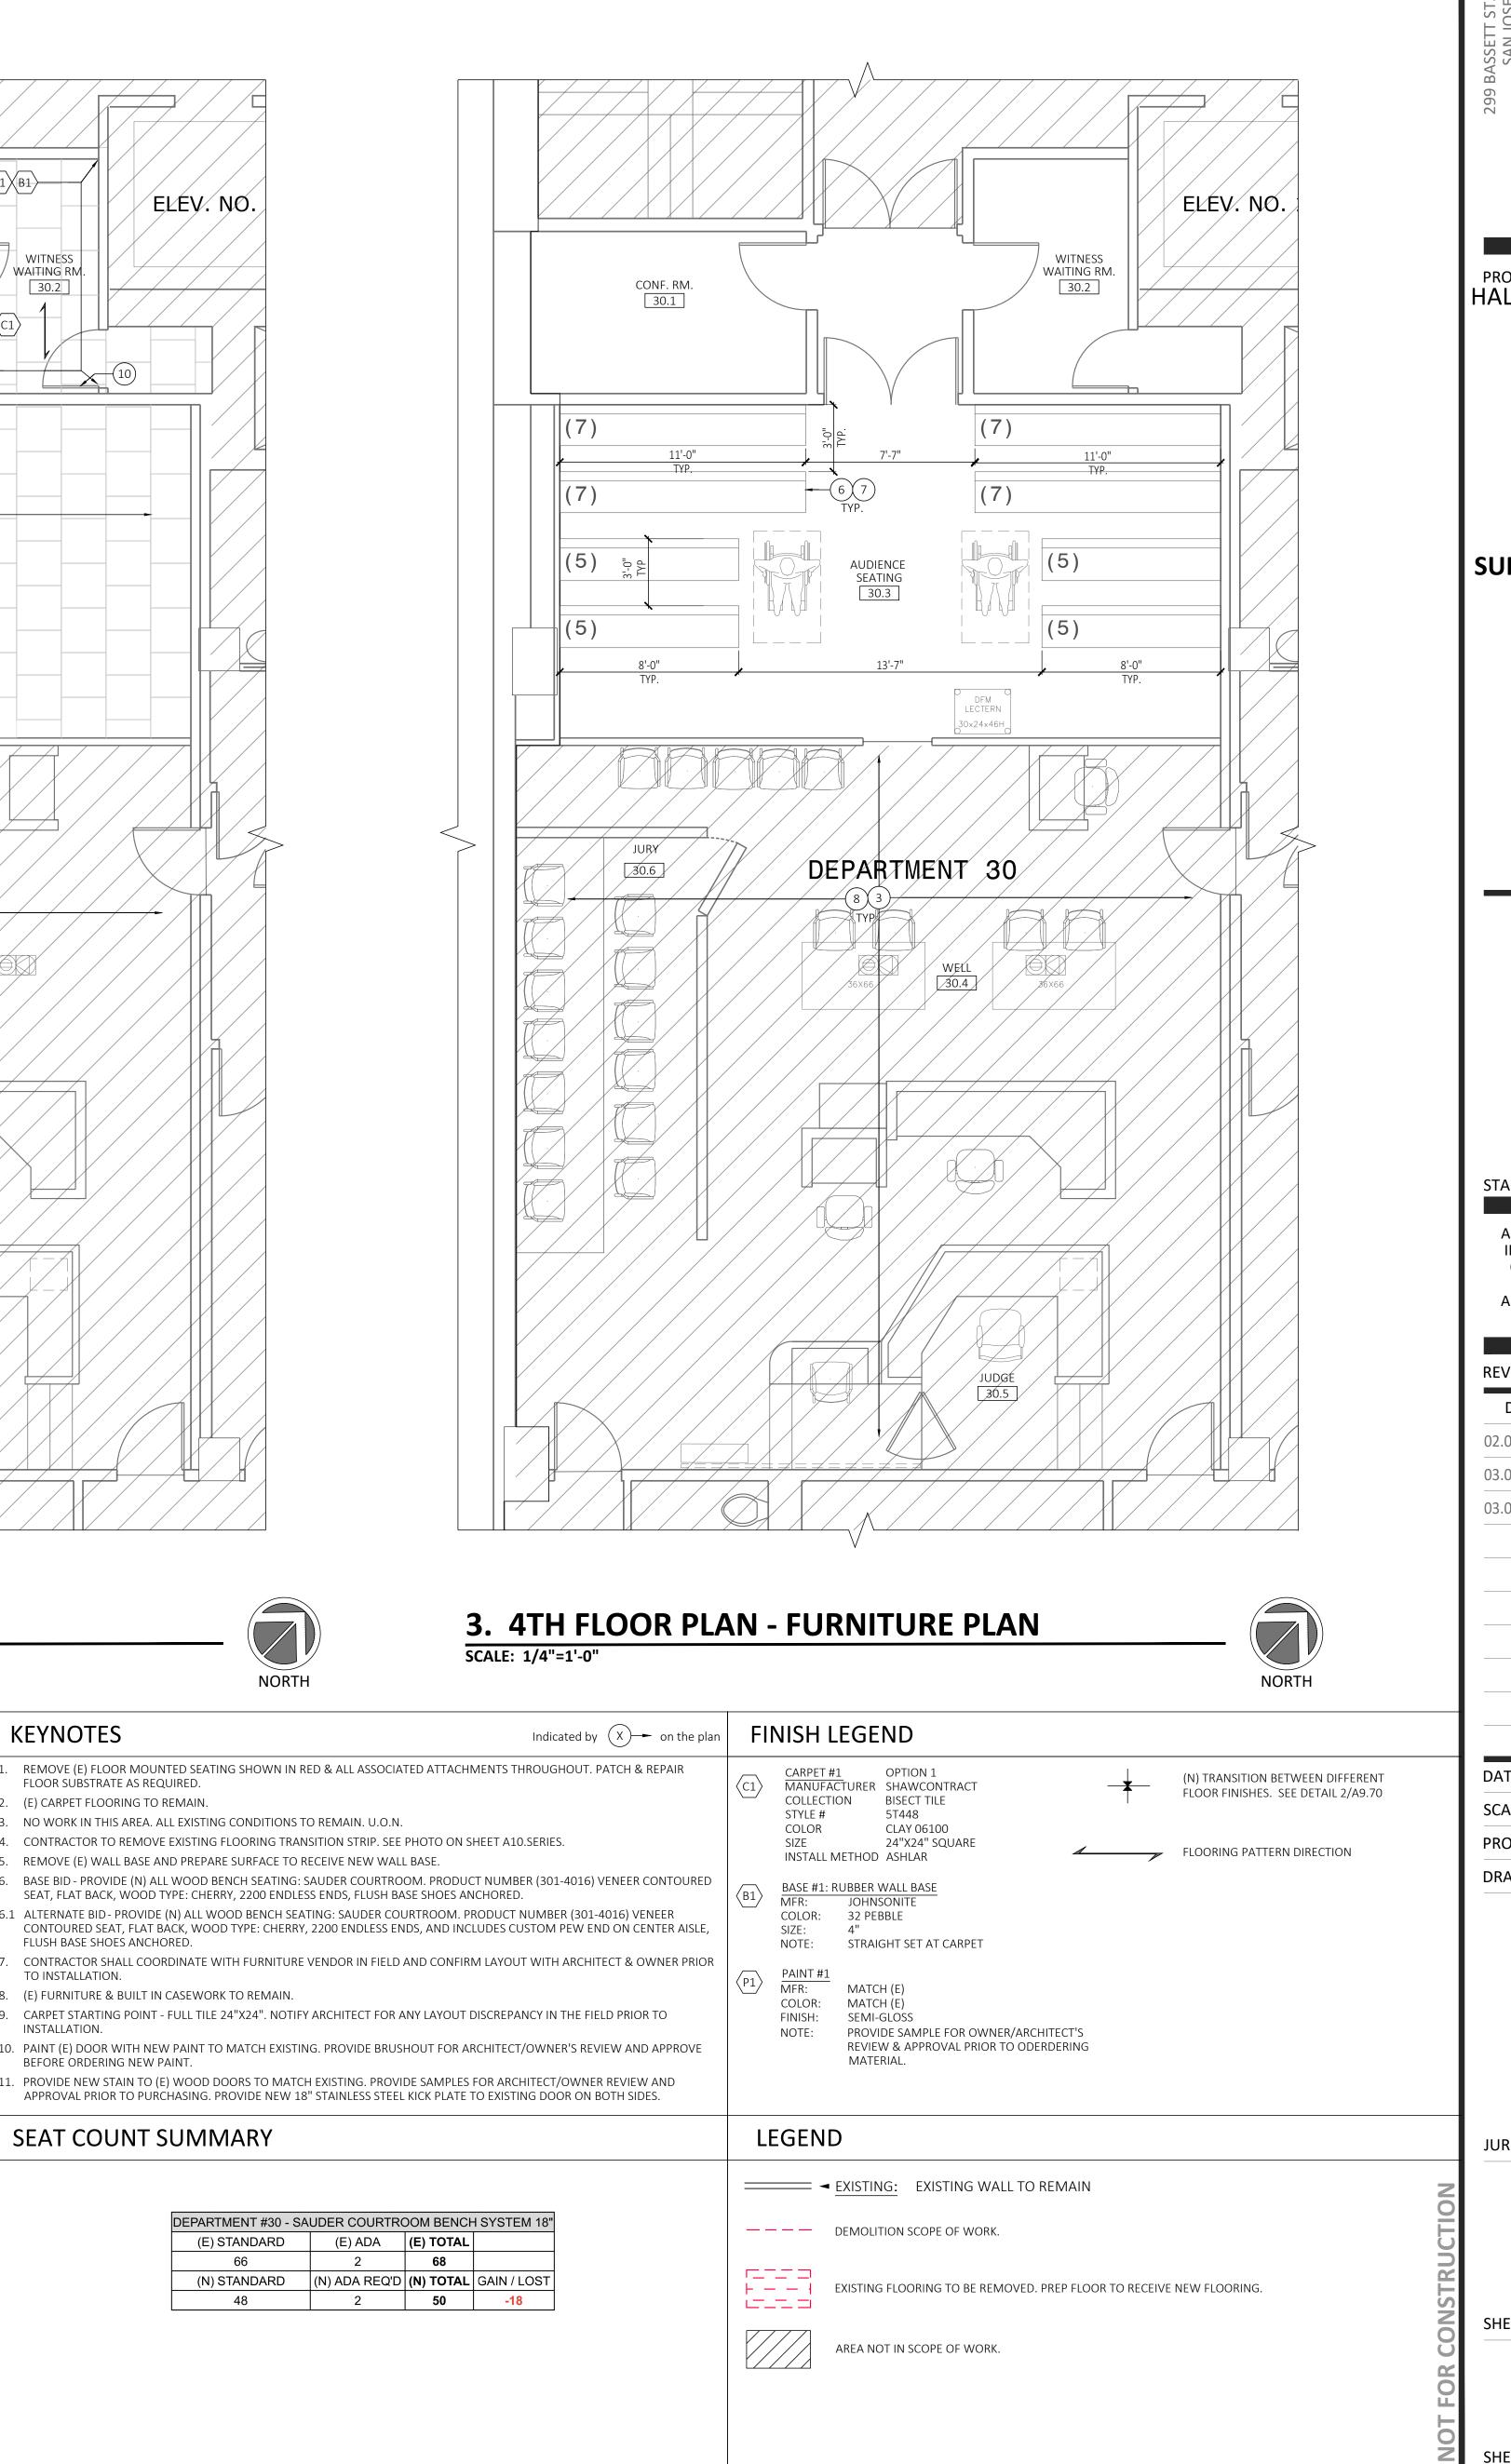





## PROJECT ADDRESS HALL OF JUSTICE EAST,4TH F,DEPT 30 190 W. HEDDING STREET SAN JOSE, CA 95110

## **TENANT IMPROVEMENT for SUPERIOR COURT OF CALIFORNIA COUNTY OF SANTA CLARA**



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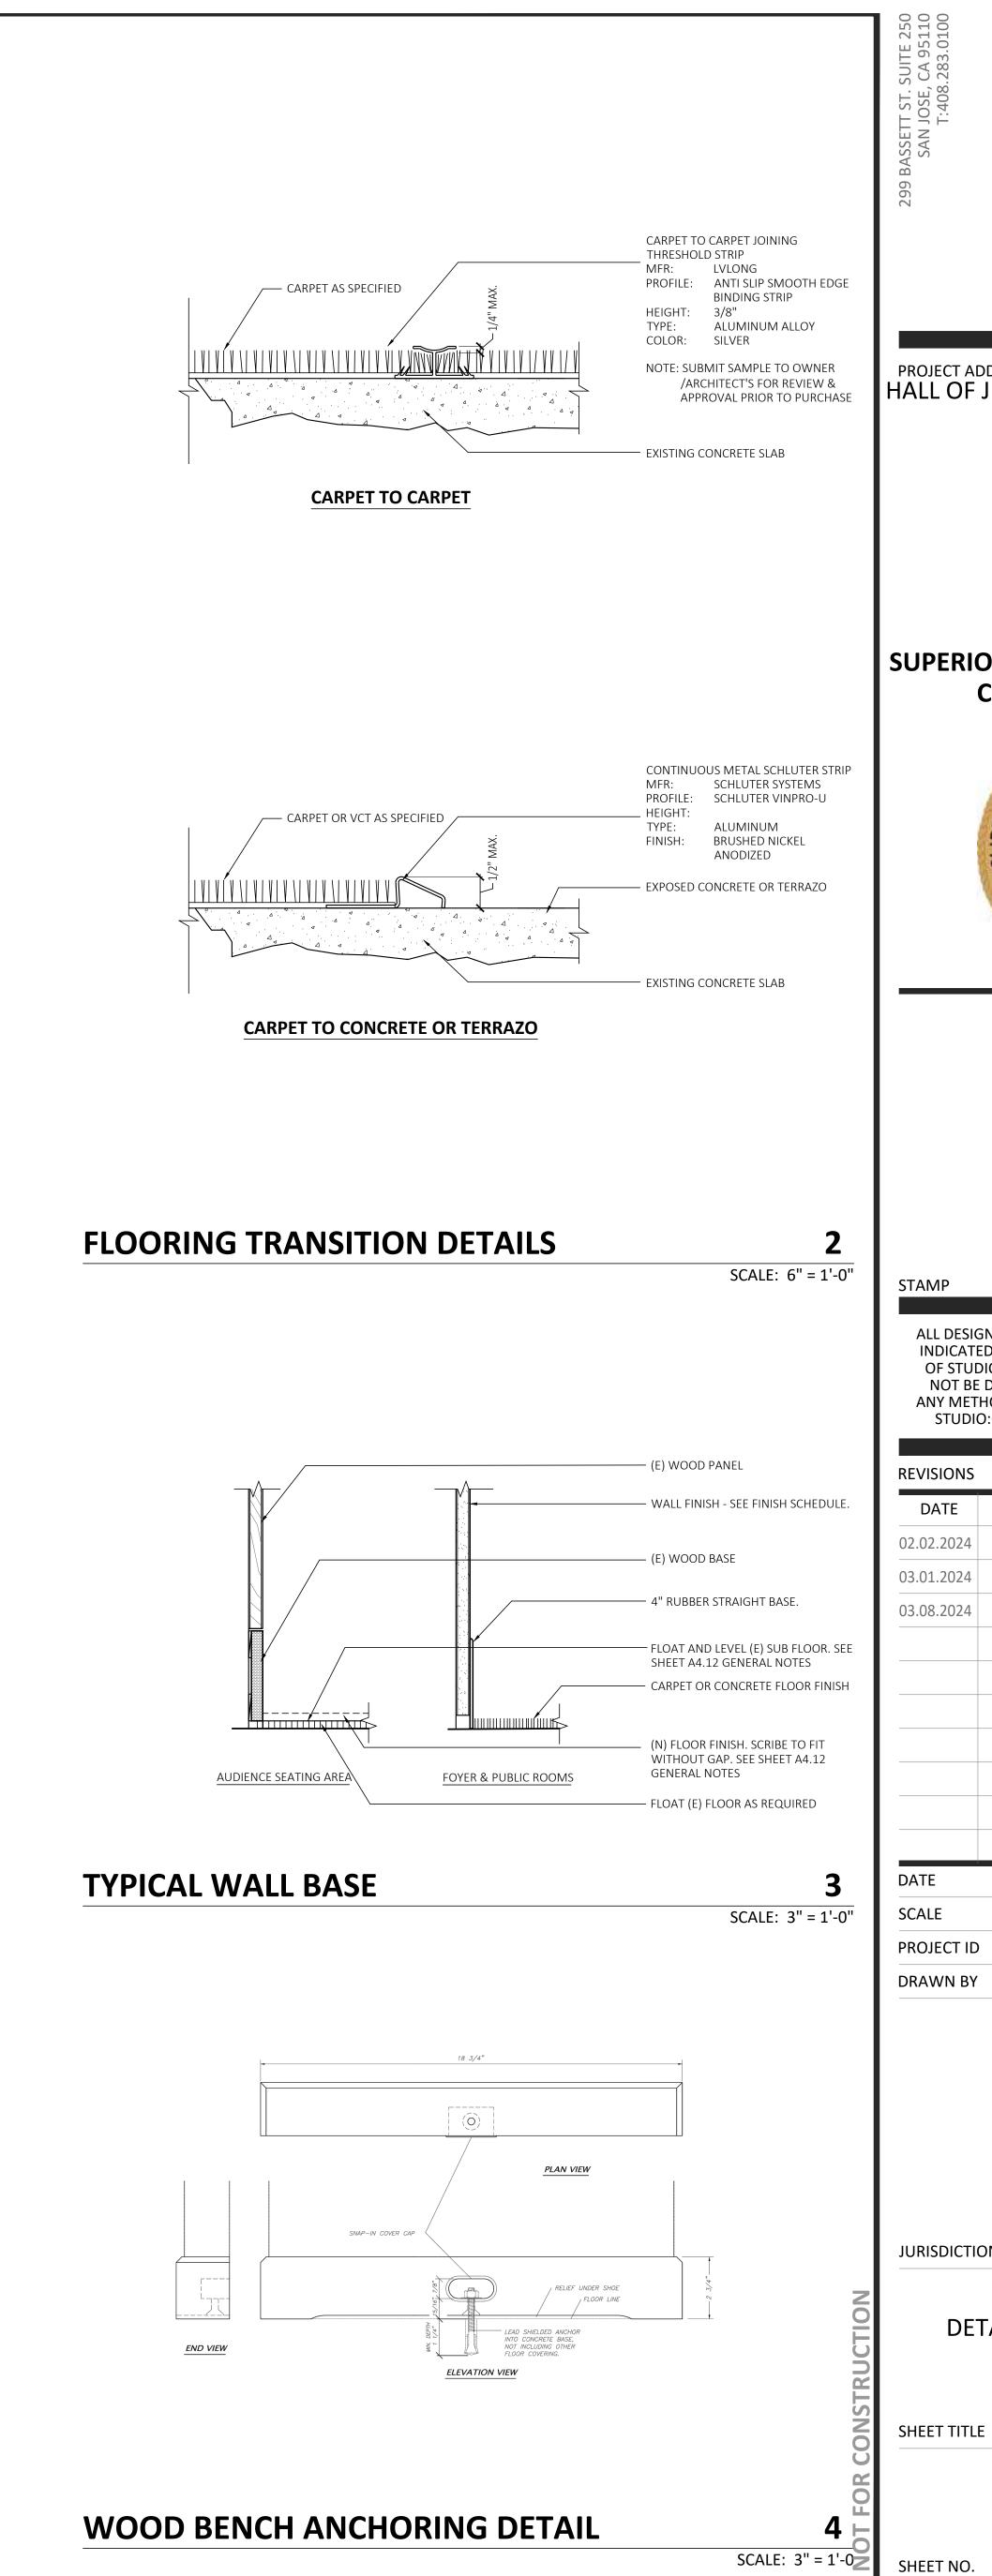
2ND FLOOR PLAN - ENLARGED

SHEET TITLE



SHEET NO.







## PROJECT ADDRESS HALL OF JUSTICE EAST,4TH F,DEPT 30 190 W. HEDDING STREET SAN JOSE, CA 95110

## TENANT IMPROVEMENT for SUPERIOR COURT OF CALIFORNIA **COUNTY OF SANTA CLARA**





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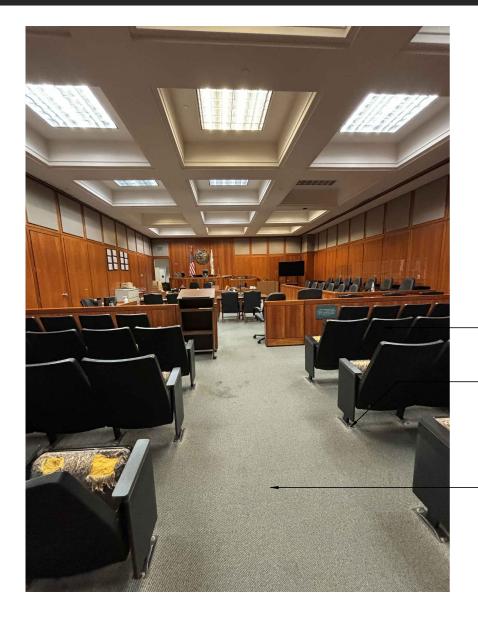
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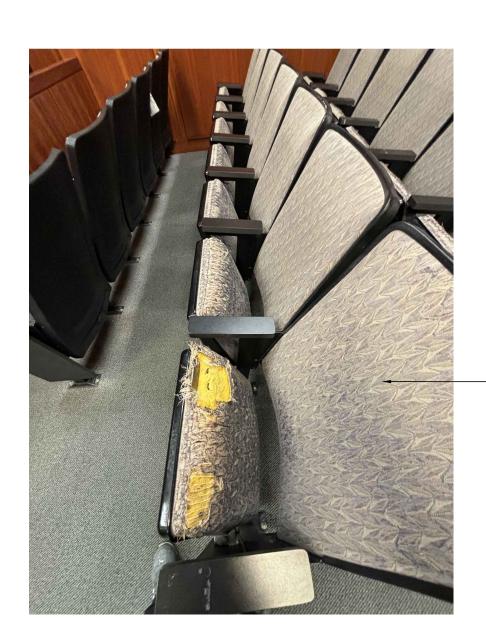
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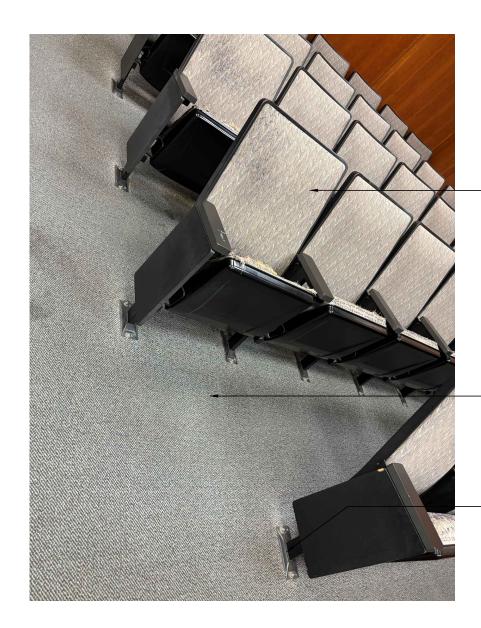
DETAILS - MISCELLANEOUS & SPECIALTIES







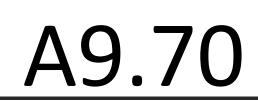

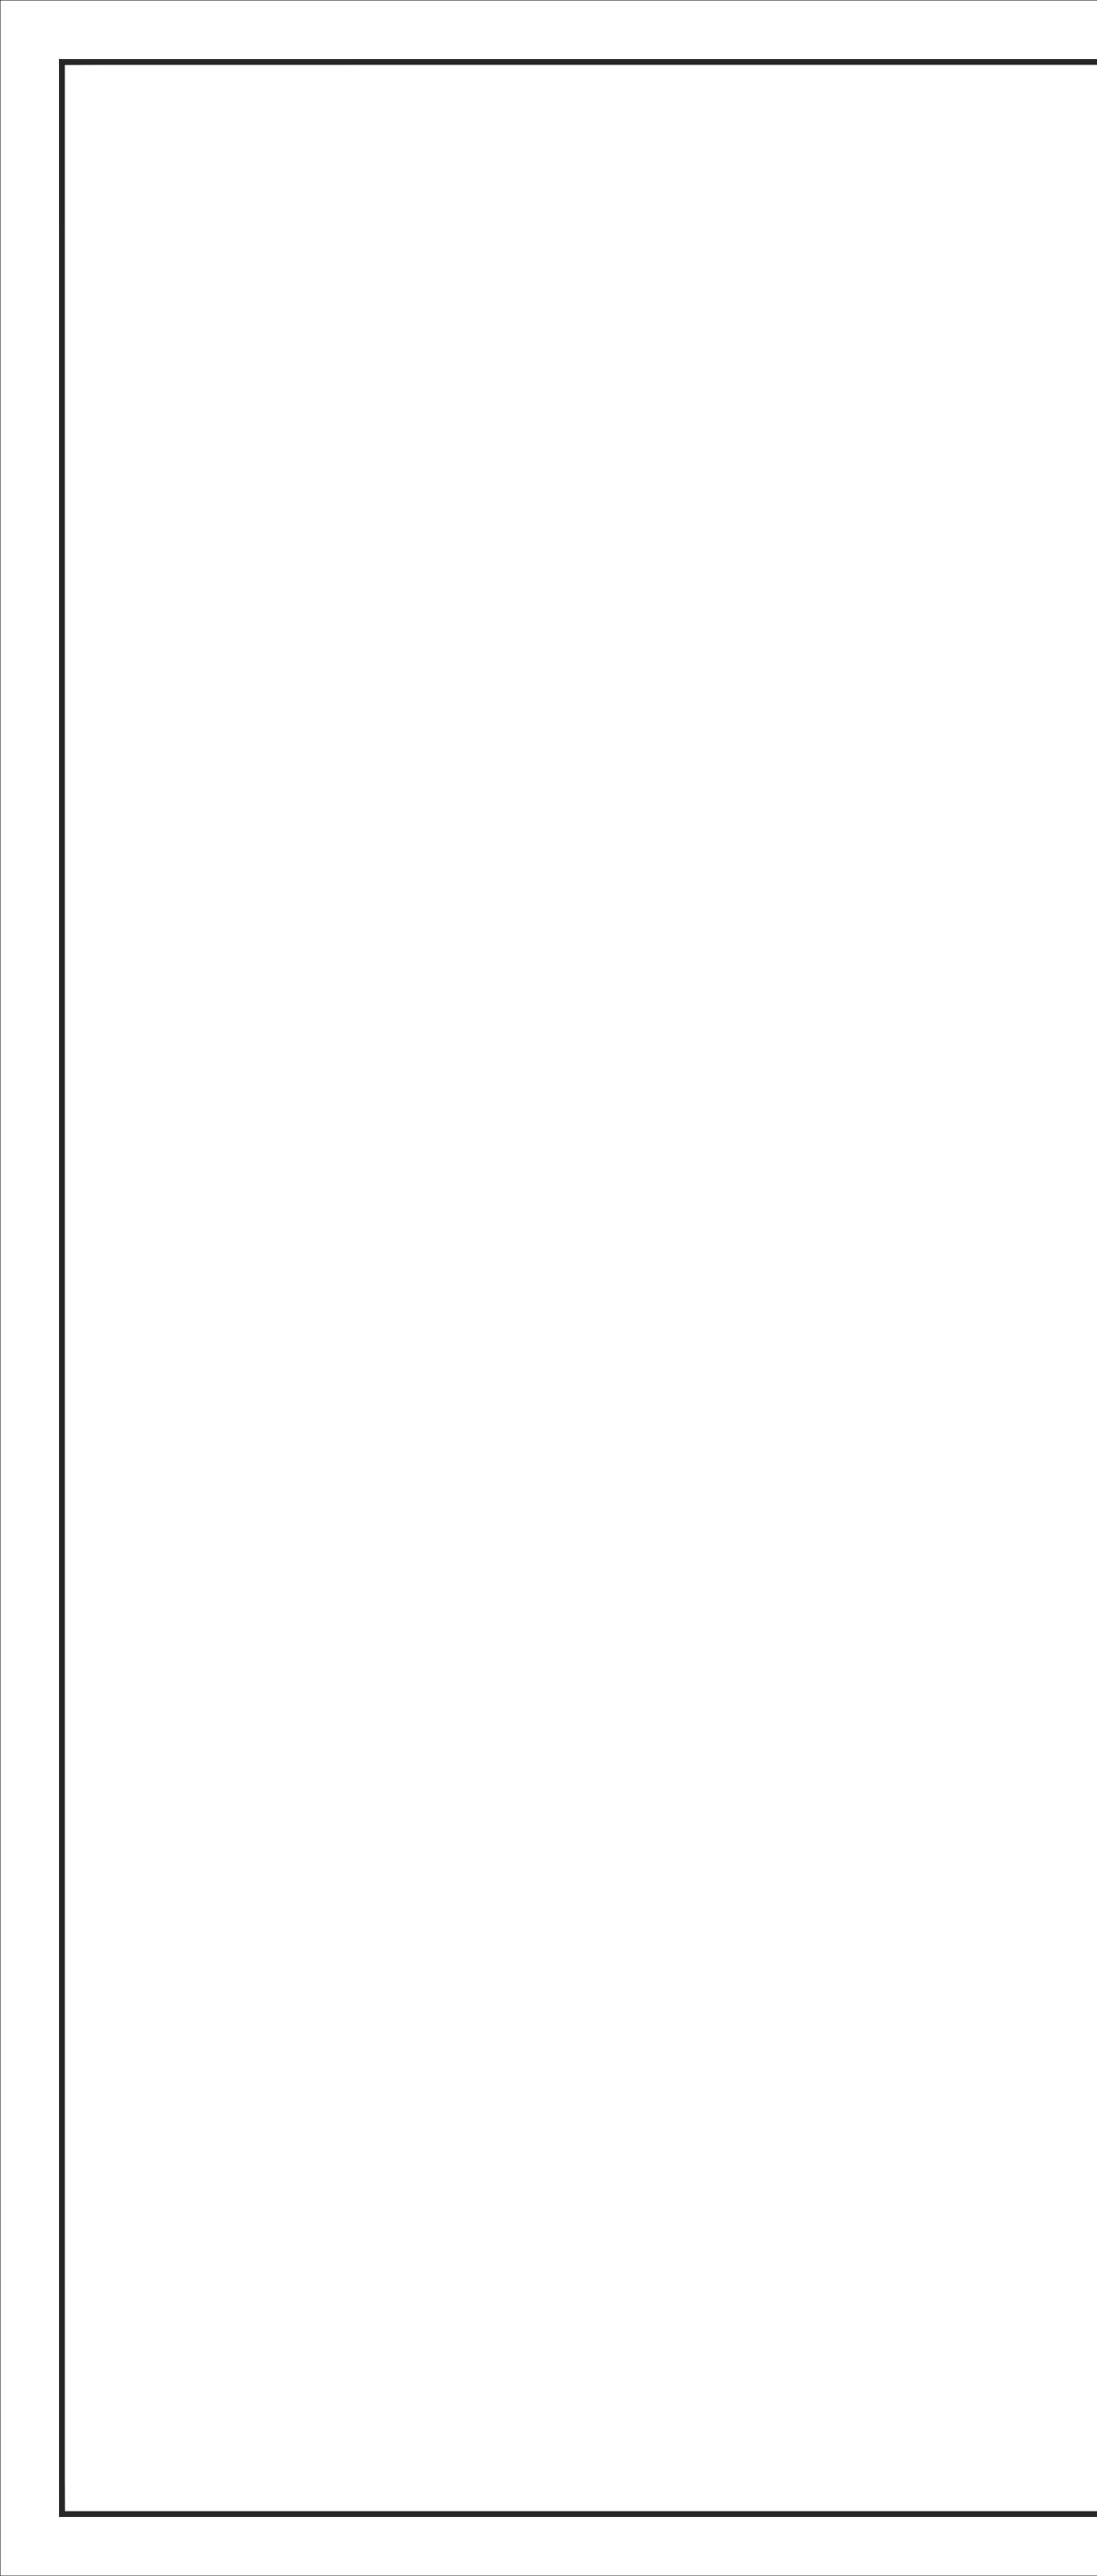



### — (E) CHAIR TO BE REMOVED AND REPLACED. SEE PLAN – (E) CHAIR PEDESTAL TO BE

REMOVED. CONTRACTOR TO COORDINATE WITH FURNITURE VENDOR IN FIELD.

5

6

REMOVE (E) CARPET, U.O.N.
 ON PLAN

— (E) CHAIR TO BE REMOVED AND REPLACED. SEE PLAN



# 

— REMOVE (E) FLOORING TRANSITION STRIP, U.O.N. ON PLAN

— (E) TERRAZZO FLOORING

(E) CARPET FLOORING TO BE REMOVED, U.O.N. ON PLAN

(E) DOOR & FRAME TO REMAIN. PAINT WITH NEW PAINT TO MATCH EXISTING. PROVIDE BRUSHOUT FOR ARCHITECT/OWNER'S REVIEW AND APPROVE BEFORE PURCHASING NEW PAINT

(E) FLOOR STRIKE TO BE REMOVED AND REINSTALLED FOR NEW FINISH FLOORING


E) FLOORING TRANSITION TO BE REMOVED, U.O.N. ON PLAN

(E) TERRAZZO FLOORING

The second se

- CONTRACTOR TO VERIFY EXISTING WALL FINISH CONDITION. PROVIDE NEW PAINT (P1) TO MATCH (E) ADJACENT FINISH

— REMOVE (E) CARPET AND RUBBER WALL BASE, U.O.N. ON PLAN

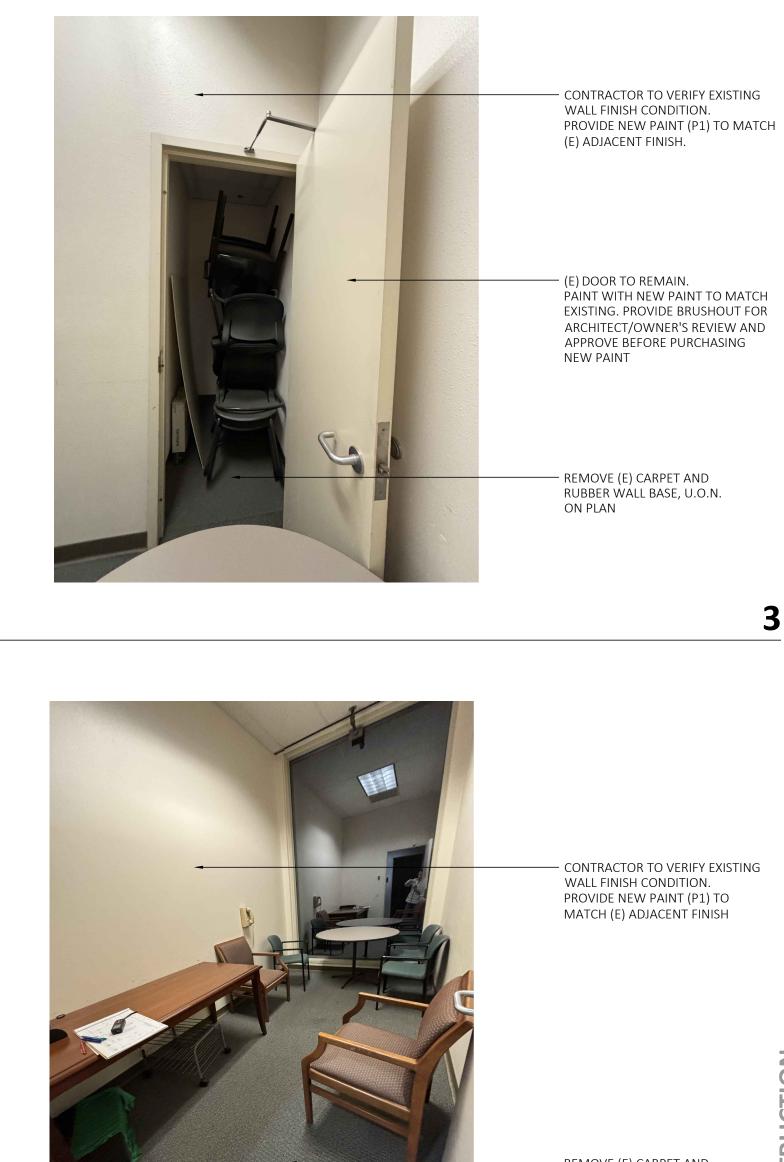

— REMOVE (E) CARPET, U.O.N. ON PLAN

— (E) FIXED CHAIR TO BE REMOVED

— (E) CHAIR PEDESTAL TO BE REMOVED. CONTRACTOR TO COORDINATE WITH FURNITURE VENDOR IN FIELD.

-

– REMOVE (E) CARPET AND RUBBER WALL BASE, U.O.N.

PAINT WITH NEW PAINT TO MATCH EXISTING. PROVIDE BRUSHOUT FOR ARCHITECT/OWNER'S REVIEW AND APPROVE BEFORE PURCHASING

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